EXHIBIT DESIGN DRAWING SET

80% FINAL DESIGN DOCUMENTS
PREPARED BY RALPH APPELBAUM ASSOCIATES
SUBMITTED FOR REVIEW DECEMBER 19, 2008

DRAWING LIST

SHEET #	DRAWING TITLE	LEVEL 3		LEVEL 4		LEVEL 5		EXHIBIT AUDIO V	ISUAL
X0-00-0.00	Drawing List	X3-LK-1.00	Partial Plan: Lake Obsv.	X4-LF-1.00	Partial Plans Life Observations Over	X5-NV-1.00	Partial Plan: Native Voices Obsv.	AV- L2	Level 2 AV Plan
X0-00-0.01	Symbols & Abbreviations	X3-LK-2.00	Elevations: Lake Obsv.	X4-LF-1.10	Partial Plan: Life Obsv Intro- Org Partial Plan: Life Obsv Org Eco	X5-NV-2.00	Elevations & Sections: Native Voices Obsv.	AV- L3	Level 3 AV Plan
DI ANIC		X3-LK-2.01	Elevations: Lake Obsv.			X5-NV-2.01	Case Elevations & Sections: Native Voices Obsv.	AV- L4	Level 4 AV Plan
PLANS		X3-LK-3.00	Details: Lake Obsv AV tables	X4-LF-2.00	Elevations & Sections: Life Obsv.	X5-NV-3.00	Details: Native Voices Obsv.	AV- L5	Level 5 AV Plan
X1-L2-0.00	Level 2 Plan	X3-LK-3.01	Details: Lake Obsv Lake floor & Intro panels	X4-LF-2.01 X4-LF-2.02	Elevations & Sections: Life Obsv.	X5-NV-3.01	Details: Native Voices Obsv.	EXHIBIT LIGHTING	G.
X2-L3-0.00	Level 3 Plan	X3-LK-3.02	Details: Lake Obsv Biota displays		Developed Elevations	X5-NV-3.02	Details: Native Voices Obsv.	EXHIBIT EIGHTING	9
X3-L4-0.00	Level 4 Plan	X3-LK-3.10	Details: Lake Obsv Wetlands Diorama/ filtation	X4-LF-2.03	Developed Elevations	X5-NV-3.10	Details: Activity tables	LX-L2-1.00	Level 2 Lighting Plan
X4-L5-0.00	Level 5 Plan	X3-LK-3.11	Details: Lake Obsv Shoreline Diorama	X4-LF-2.04	Developed Elevations	X5-NV-3.20	Details: Storytelling Area	LX-L3-1.00	Level 3 Lighting Plan
LEVEL 2		X3-LK-4.10	Interactives: Wetlands Filtration	X4-LF-2.05	Developed Elevations	X5-NV-5.10	Exhibit Case Layouts: National Tribes	LX-L4-1.00	Level 4 Lighting Plan
				X4-LF-3.00	Details -Typical Sections	X5-NV-5.20	Exhibit Case Layouts: Ute	LX-L5-1.00	Level 5 Lighting Plan
X2-TH-1.00	Partial Plan: Canyon Trailhead	X3-LK-4.20	Interactives: Lake Formation	X4-LF-3.01	Details - Wall/ Panel Details	X5-NV-5.30	Exhibit Case Layouts: Shosone	LX-L2-0.01	Level 2 RCP
X2-TH-2.00	Elevations & Sections: Canyon Trailhead	X3-LK-4.21	Interactives: Lake Formation	X4-LF-3.10	Details: DNA	X5-NV-5.40	Exhibit Case Layouts: Goshute	LX-L3-0.01	Level 3 RCP
X2-TH-2.01	Elevations & Sections: Canyon	X3-FP-1.00	Partial Plan: First Peoples Obsv.	X4-LF-3.11	Details: DNA			LX-L4-0.01	Level 4 RCP
X2-TH-3.00	Details: Trailhead Topo map	X3-FP-2.00	Elevations & Sections: First Peoples Obsv.	X4-LF-3.12	Details: DNA helix	X5-SK-1.00	Partial Plan: Sky Obsv.	LX-L5-0.01	Level 5 RCP
X2-TH-3.10	Details: Canyon	X3-FP-2.00 X3-FP-2.01	Elevations & Sections: First Peoples Obsv.	X4-LF-3.20	Details: Cells	X5-SK-1.00 X5-SK-2.00		LX1-TH-1.00	Level 2 Trail Head Plan
X3-MH-1.00	Partial Plan: Mineral Hall	X3-FP-2.02		X4-LF-3.30	Details: Organisms	X5-SK-2.00 X5-SK-2.01	Elevations & Sections: Sky Obsv. Elevations & Sections: Sky Obsv.	LX2-UF-1.00	Level 2 Utah Futures Plan
X3-MH-2.00	Elevations & Sections: Mineral Hall		Elevations & Sections: First Peoples Obsv.	X4-LF-3.31 X4-LF-3.32	Details: Organisms - Live Display	X5-SK-3.00	Details: Helioscope/ Sun Table	LX2-UF-1.02	Level 2 Utah Futures RCP
X2-UF-1.00	Partial Plan: Utah Futures Obsv.	X3-FP-3.00	Details: First Peoples median village details	X4-LF-3.32 X4-LF-3.40	Details: Organisms - Live Display Details: Populations	X5-SK-3.10	Details: Sky Terrace Equipment	LX2-BY-1.00	Level 2 Our Backyard Plan
X2-UF-2.00	Elevations & Sections: Utah Futures Obsv.	X3-FP-3.01	Details: First Peoples median village details	X4-LF-3.50	Details: Populations Details: Ecosystem - Hot Desert	X3 6K 6.16	because only remade Equipment	LX2-BY-1.02	Level 2 Our Backyard RCF
X2-UF-3.00	Details: Utah Futures Obsv.	X3-FP-3.02	Details: FP Obsv Interactive/ touch object tables	X4-LF-3.60	Details: Ecosystem - Cold Desert			LX2-BY-2.00	Level 2 Our Backyard
X2-UF-5.10	Exhibit Case Layouts: Carbon Story	X3-FP-3.03	Details: FP Obsv median village details	X4-LF-3.70	Details: Ecosystem - Cold Desert Details: Ecosystem - Montane Forest	TYPICAL DETAILS		LX2-PW-1.00	Level 2 Past Worlds Plan
		X3-FP-4.10	Interactives: FP Activity tables	X4-LF-3.80	Details: Ecosystem - Alpine Details: Ecosystem - Alpine			LX2-PW-1.02	Level 2 Past Worlds RCP
X2-BY-1.00 X2-BY-2.00	Partial Plan: 'Our Backyard'	X3-FP-4.11	Interactives: FP Activity tables	X4-LF-3.90	Details: Human Interactions	X-TYP-1.00	Typical Details: Glass Cases - Schedule	LX2-PW-2.00	Level 2 Past Worlds
X2-BY-2.10	Elevations & Sections: 'Our Backyard' Elevations & Sections: House Area	X3-FP-5.10	Exhibit Case Layouts: Settlement/ Subsistence	X4-LF-4.00	Interactives: Protein Synthesis	X-TYP-1.10	Typical Details: Glass Cases - Brackets and Plinths	LX2-EL-1.00	Level 2 Earth Lab Plan
X2-BY-3.00	Details: 'Our Backvard' – water table	X3-FP-5.20	Exhibit Case Layouts: Trade	X4-LF-4.10	Interactives: Freein Synthesis Interactives: Keratin Sequencing Game	X-TYP-1.20-alt A	Typical Details: Glass Cases - Typical	LX2-EL-1.02	Level 2 Earth Lab RCP
X2-BY-3.01	Details: 'Our Backyard' – water table Details: 'Our Backyard' – underground crawl	X3-FP-5.30	Exhibit Case Layouts: Weapons/ Stone Tools	X4-LF-4.10 X4-LF-4.20	Interactives: Relatin Sequencing Game Interactives: Build a Plant cell	X-TYP-1.20-alt B	Typical Details: Glass Cases - Typical	LX2-EL-2.00	Level 2 Earth Lab
X2-BY-3.02		X3-FP-5.40	Exhibit Case Layouts: Ornaments	X4-LF-4.21	Interactives: Build a Plant Cell	X-TYP-1.30	Typical Details: Glass Cases - NV	LX3-LK-1.02	Level 3 Lake RCP
X2-B1-3.UZ	Details: 'Our Backyard' – free play area	X3-FP-5.50	Exhibit Case Layouts: Footwear			X-TYP-1.40	Typical Details: Glass Cases - CLQ	LX3-LK-2.01	Level 3 Lake
X2-PW-1.00	Partial Plan: Past Worlds Obsv. (Lower) -EO/LC	X3-FP-5.60		X4-LF-4.30	Interactives: Photosynthesis	X-TYP-1.50	Typical Details: Table Cases	LX3-FP-1.00 LX3-FP-1.02	Level 3 First Peoples Plan Level 3 First Peoples RCP
X2-PW-1.10	Partial Plan: Past Worlds Obsv. (Lower) -LJ	X3-FP-5.70	Exhibit Case Layouts: Ceramics/ Typology Exhibit Case Layouts: Textiles/ Basketry	X4-LF-4.50	Interactives: Pollenation	X-TYP-2.00	Typical Details: Acylic Cases - Schedule	LX3-FP-2.00	Level 3 First Peoples
X3-PW-1.00	Partial Plan: Past Worlds Obsv. (Upper) -EO/LC		EXHIBIT Case Layouts. Textiles/ Basketry	X4-LF-4.60	Interactives: Jaw Movement	X-TYP-2.01	Typical Details: Acylic Cases	LX3-DC-1.00	Level 3 Danger Cave Plan
X2-PW-2.00	Elevations & Sections: Past Worlds Obsv.	X3-DC-1.00	Partial Plan: Danger Cave	X4-LF-5.10	Exhibit Case Layouts: Keratins	X-TYP-2.02	Typical Details: Acylic Cases	LX3-DC-1.02	Level 3 Danger Cave RCP
X2-PW-2.01	Elevations & Sections: Past Worlds Obsv.	X3-DC-2.00	Sections & Elevations: Danger Cave	X4-NL-1.00	Partial Plan: Naturalist Lab	X-TYP-2.03	Typical Details: Acylic Cases	LX3-DC-2.00	Level 3 Danger Cave
X2-PW-2.02	Platform Elevations: Past Worlds ObsvPL			X4-NL-2.00	Elevations & Sections: Naturalist Lab	X-TYP-3.00	Typical Details: Exhibit Rails - Ramps	LX3-LD-1.00	Level 3 Land Plan
X2-PW-2.03	Platform Elevations: Past Worlds ObsvEO	X3-LD-1.00	Partial Plan: The Land Obsv.	A4-NL-2.00	Lievations & Sections, Naturalist Lab	X-TYP-3.10	Typical Details: Exhibit Case Rails	LX3-LD-1.02	Level 3 Land RCP
X2-PW-2.04	Platform Elevations: Past Worlds ObsvLC	X3-LD-2.00	Elevations & Sections: The Land Obsv.			X-TYP-3.20	Typical Details: Exhibit Rails - Typical	LX3-LD-2.01	Level 3 Land
X2-PW-2.05	Platform Elevations: Past Worlds ObsvLJ	X3-LD-2.01 X3-LD-2.02	Elevations & Sections: The Land Obsv. Elevations & Sections: The Land Obsv.			X-TYP-3.30	Typical Details: Exhibit Rails - Slab edge	LX3-LD-2.02	Level 3 Land
X2-PW-3.00	Details: Cretaceous Diorama	X3-LD-2.02 X3-LD-2.03	Elevations & Sections: The Land Obsv. Elevations & Sections: The Land Obsv.			X-TYP-3.40	Typical Details: Exhibit Rails - AV & Terrace	LX4-LF-1.00	Level 4 Life Plan
X2-PW-3.10	Details: Eocene Diorama	X3-LD-3.00	Details: MRM Sections					LX4-LF-1.02	Level 4 Life RCP
X2-PW-4.10	Interactives: Build a Mammoth & Ice Age Dinner Table	X3-LD-3.10	Details: CP Plan Countertop & Millwork					LX4-LF-2.00	Level 4 Life
X2-PW-4.20	Interactives: Gryposaurus Activities & Dino Dig	X3-LD-3.11	Details: CP/ B&R Sections					LX4-NL-1.00	Level 4 Naturalist Lab Pla
X2-PW-4.30	Interactives: Clevland Llyod Quarry	X3-LD-3.20	Details: Earthquake Area					LX4-NL-1.02	Level 4 Naturalist Lab RC
X2-PW-5.10	Exhibit Case Layouts: Pleistocene Mammals	X3-LD-3.30	Details: Human Interactions					LX5-NV-1.00	Level 5 Native Voices Plan
X2-PW-5.20	Exhibit Case Layouts: Eocene Green River	X3-LD-3.40	Details: Homestead Cave					LX5-NV-1.02	Level 5 Native Voices RCI
X2-PW-5.30	Exhibit Case Layouts: LC North Horn Formation	X3-LD-3.50	Details: Utah's Cambrian					LX5-NV-2.01 LX5-SK-1.00	Level 5 Native Voices Level 5 Sky Plan
X2-PW-5.40	Exhibit Case Layouts: LC Cedar Mountain	X3-LD-4.00 X3-LD-4.01	Interactives: Erosion table Interactives: Erosion table					LX5-SK-1.00 LX5-SK-1.02	Level 5 Sky RCP
X2-PW-5.50	Exhibit Case Layouts: LC Kaiparowits Diversity	X3-LD-4.01 X3-LD-4.10	Interactives: Erosion table Interactives: Earthquake Platform					LX5-SK-2.00	Level 5 Sky
X2-PW-5.51	Exhibit Case Layouts: LC Kaiparowits Diversity	X3-LD-4.11	Interactives: Earthquake Platform					LA3 3K-2.00	20701 3 3ky
	· · · · · · · · · · · · · · · · · · ·	X3-LD-4.20	Interactives: Expansion						
X2-PW-5.52	Exhibit Case Layouts: LC Kaiparowits Diversity	X3-LD-4.21	Interactives: Expansion						
X2-PW-5.60	Exhibit Case Layouts: LJ Clevland Llyod Quarry	X3-LD-4.30	Interactives: Plant Smell/ Flip-books						
			•						

UTAH MUSEUM OF NATURAL HISTORY

UNIVERSITY OF UTAH, SALT LAKE CITY, UTAH


X2- EL-1.00

Partial Plan: Earth Lab Elevations & Sections: Earth Lab

Structural Engineer

BBI Engineering, Inc. 241 Quint Street San Francisco, CA 94124 415 685 9555 tel.

Exhibit Construction Ralph Appelbaum Associates 88 Pine Street New York, New York 10005 212.334.8200 tel.

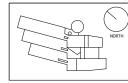

Key Plan

Sheet Title
Drawing List

Date Project No. 0275 June 2, 2008 Scale* Sheet No.

No. / Issue Name / Date

X0-00-0.00

GENERAL NOTES

1. ANY VARIANCE BETWEEN THE DRAWINGS AND SPECIFICATIONS NOTED BY THE CONTRACTOR OR SUBCONTRACTORS SHALL BE PROMPTLY NOTED AND TRANSMITTED TO THE OWNER AND EXHIBIT DESIGNER IN WRITING.

2. IF THE CONTRACTOR OBSERVES THAT ANY PORTION OF THE DRAWINGS IS AT VARIANCE IN ANY RESPECT WITH 2. IF THE CONTINCT ON OBSERVES THAT ANY PORTION OF THE DAMPHICAS IS AT VARIANCE HAVE ANY MORE SECTION.

APPLICABLE LAWS, BUILDING CODES OR REGULATIONS, THE CONTRACTOR IS RESPONSIBLE FOR NOTIFYING THE OWNER AND EXHIBIT DESIGNER PROMPTLY IN WRITING. IF THE CONTRACTOR PERFORMS ANY WORK CONTRARY TO ANY CODES OR REGULATIONS, THE CONTRACTOR SHALL ASSUME FULL RESPONSIBILITY THEREFOR AND SHALL BEAR ALL COSTS

3. NEITHER THIS DRAWING, NOR ANY SUCH IDEAS, ARRANGEMENTS, DESIGNS OR PLANS SHALL BE APPROPRIATED BY OR DISCLOSED TO ANY PERSON, FIRM OR CORP. FOR ANY PURPOSE EXCEPT BY THE SPECIFIC WRITEN PERMISSION OF

4. WRITTEN DIMENSIONS ON DRAWINGS SHALL HAVE AUTHORITY OVER SCALED.CONTRACTORS AND MANUFACTURERS SHALL VERIFY AND BE RESPONSIBLE FOR ALL DIMENSIONS AND CONDITIONS ON THE JOB AND INFORM RAA OF ALL VARIATIONS FROM THE DRAWINGS PRIOR TO PERFORMANCE OF WORK.


5. RAA SHALL FIRST SEE AND APPROVE CONTRACTORS FULL SIZE SHOP DRAWINGS PRIOR TO ANY FABRICATION.

6. THE EXHIBIT DESIGN DRAWINGS HEREWITH REPRESENT DESIGN INTENT ONLY. IT IS THE RESPONSIBILITY OF THE FABRICATOR TO VERIFY AND INSURE STRUCTURAL INTEGRITY OF THE DESIGN WITH A LICENSED STRUCTURAL ENGINEER AND ASSURE THAT ALL LOCAL CODES AND REGULATIONS ARE FULFILLED.

7. ALL INTERACTIVES SHALL BE ENGINEERED AND PROTOTYPED PRIOR TO FABRICATION. TESTING AND CLIENT REVIEW SHALL BE PART OF OVERALL FABRICATION SCHEDULE.

GRAPHIC SYMBOLS

SEE 0 / XX-XX-00

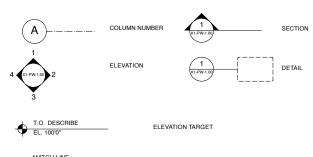

ABBREVIATIONS

AV	AUDIO VISUAL	I.D.	INSIDE DIMENSION/DIAMETER
AVI	AUDIO VISUAL INTEGRATOR	I.F.	INSIDE FACE
ABV.	ABOVE	INCL.	INCLUDE
A.R.E	ABOVE REFERENCE ELEVATION	INFO.	INFORMATION
ADJ.	ADJACENT OR ADJUSTABLE	INSUL.	INSULATION
A/C AL.	AIR CONDITIONING ALUMINUM	INT. JT.	INTERIOR JOINT
AL. ANOD.	ANODIZED		
APPRX.	APPROXIMATE	LAM.	LAMINATED
ARCH.	ARCHITECT(URAL)	LH LT.	LEFT HAND LIGHT
ASP	ACTIVATED SOUND PANEL	LOC.	LOCATION
BLKG.	BI OCKING		
BD.	BOARD	MAX. MFRG.	MAXIMUM MANUSACTURER(INC)
BLDG.	BUILDING	MFRG. MFCH.	MANUFACTURER(ING) MECHANICAL
BM.	BEAM	MED.	MEDIUM
BOT.	ВОТТОМ	MTL.	METAL
BTWN.	BETWEEN	MIN.	MINIMUM
B.O.	BY OTHERS OR BOTTOM OF	MISC.	MISCELLANEOUS
C.I.P.	CAST IN PLACE	(N)	NEW
CLG.	CEILING	N	NORTH
Q_	CENTER LINE	(NIC)	NOT IN CONTRACT
CL.	CLOSET CEILING	N.T.S.	NOT TO SCALE
CLG. CLR.	CLILING CLEAR	O.C.	ON CENTER
CLR. CM.	CONSTRUCTION MANAGER	O.D.	OUTSIDE DIMENSION/DIAMETER
CMU.	CONCRETE MASONRY UNIT	O.F.	OUTSIDE FACE
COL.	COLUMN	OPG.	OPENING
CONC.	CONCRETE	OPP.	OPPOSITE
CONST.	CONSTRUCTION	PL.	PLATE
CONT.	CONTINUOUS OR CONTINUE	PLYWD.	PLYWOOD
CP.	CENTER POINT	PPA	POLSHEK PARTNERSHIP ARCHITECT:
CTR.	CENTER	PRELIM. PT.	PRELIMINARY POINT
DEMO.	DEMOLITION	PTD.	PAINTED
DEMO. DEPT	DEPARTMENT	PTN.	PARTITION
DET.	DETAIL	R	RADIUS
DES.	DESIGNER	RAA	RALPH APPELBAUM ASSOCIATES
DIA.	DIAMETER	R.C.P.	REFLECTED CEILING PLAN
DIAG.	DIAGONAL	REF.	REFERENCE
DIM.	DIMENSION	REINF.	REINFORCE (D) (ING)
DR.	DOOR	REQ'D.	REQUIRED
DN.	DOWN	RH.	RIGHT HAND
DWG.	DRAWING	REV.	REVISED
(E)	EXISTING	S	SOUTH SCHEDULE
E E-W	EAST EAST-WEST	SCHED. SHT.	SHEET
E-VV FΔ	FACH	SIM.	SIMII AR
FF.	EACH FACE	SPEC.	SPECIFICATION
ELEC.	ELECTRICAL	SQ.	SQUARE
EL.	ELEVATION	SQ. FT.	SQUARE FOOT
EMER.	EMERGENCY	SS.	SILK SCREEN
EQ.	EQUAL	ST. STL.	STAINLESS STEEL
EQUIP.	EQUIPMENT	STL.	STEEL
EXT.	EXTERIOR	STD.	STANDARD STRUCTURAL
FIN.	FINISH	STRUC.	
F.F. FI R.	FINISH FLOOR	TBD	TO BE DETERMINED
FLK. FLUOR.	FLOOR FLUORESCENT	TEL.	TELEPHONE
F.O.G.	FACE OF GLASS	TEMP. THK.	TEMPERED THICK
F.O.W.	FACE OF WALL	THK.	THROUGH
FT.	FOOT	TOC.	TOP OF CONCRETE
FURR.	FURRING	TYP.	TYPICAL
G.C.	GENERAL CONTRACTOR	U.O.N.	UNLESS OTHERWISE NOTED
GT.	GROUT	U.V.	ULTRA VIOLET
GYP. BD.	GYPSUM BOARD	VERT.	VERTICAL
HD. WD.	HARD WOOD	V.I.F.	VERIFY IN FIELD
H.V.A.C.	HEATING, VENTILATION & A/C	W	WEST, WIDTH, WIDE
HT.	HEIGHT	W/	WITH
H.M.	HOLLOW METAL	W/O	WITHOUT
		WD.	WOOD
		XC.	EXHIBIT CONTRACTOR

FINISH SCHEDULE

MFT	TAL SCHEDULE						
	EXHIBIT FINISH CODE	DESCRIPTION	COLOR	SPEC	SUPPLIER	CONTACT/ REP	COMMENTS
1	X-MTL-1	BLACK METAL				CONTACT/ REF	BLACK TINTED LACQUER
2	X-MTL-2	CORTEN STEEL					
		CONTENTOTEEE					
	ISH SCHEDULE	T	T	Г	T		1
NO.	EXHIBIT FINISH CODE	DESCRIPTION	COLOR	SPEC	SUPPLIER	CONTACT/ REP	COMMENTS
1	X-WD-1	WOOD VENEER PANELS	TBD	COR PRODUCT	BETTONCOURT		TABLE BASES
2	X-WD-2	RECYCLED PAPER PANELS	TBD	PAPERSTONE OR EQ.	BETTONCOURT		RAILS/ TABLETOPS
3	X-WD-3	DIMENSIONAL LUMBER	TBD	MAPLE VENEER			LIFE ECOSYSTEM PANELS
4	X-PN-1	TRANSCLUSCENT PANELS	TBD	LUMISITE OR 3 FORM RESIN			LIFE PANELS
5	X-MDF-1	TINTED LAQUERED MDF	TBD	MEDITE II W/ LOW VOC SEAL	SIERRA PINE		TYPICAL WALL PANELS
6	X-RB-1	RECYCLED RUBBER	TBD	ECOSURFACES OR EQ.			OUR BACKYARD /DANGER CAVE
7	X-ST-1	STONE COMPOSITE PANEL	TBD	FIRESLATE OR EQUAL			OUR BACKYARD WATER AREA
8	X-ST-2	SANDSTONE SLAB	TBD	3" TH. ROUGH SLAB	STATE STONE		LAND COLORADO PLATEAU TABLES
9	X-F-1	WOOL FELT	TBD	BUFFALO FELT OR EQ.			OUR BACKYARD TREE
10	X-F-2	STRETCHED FABRIC	TBD	CREATION BAUMANN OR EQ.			OUR BACKYARD TREE
11	X-F-3	FABRIC ON SUBSTRATE	TBD	TBD			NATIVE VOICES CASES
12	X-C-1	CEMENTICIOUS SCIM COAT	TBD				PW PLATFORMS
13	X-C-2	CEMENTICIOUS SCIM COAT	TBD				OUR BACKYARD
PAII	NT SCHEDULE					_	
NO.	EXHIBIT FINISH CODE	DESCRIPTION	COLOR	SPEC	SUPPLIER	CONTACT/ REP	COMMENTS
1	X-PT-1	LATEX PAINT FINISH	WHITE	PRIMER + 2 COATS OF FINISH	BENJAMIN MOORE OR EQUAL		FINAL COLOR SPEC # TBD
2	X-PT-2	LATEX PAINT FINISH	TBD	PRIMER + 2 COATS OF FINISH	BENJAMIN MOORE OR EQUAL		FINAL COLOR SPEC # TBD
3	X-PT-3	LATEX PAINT FINISH	TBD	PRIMER + 2 COATS OF FINISH	BENJAMIN MOORE OR EQUAL		FINAL COLOR SPEC # TBD
4	X-PT-4	LATEX PAINT FINISH	TBD	PRIMER + 2 COATS OF FINISH	BENJAMIN MOORE OR EQUAL		FINAL COLOR SPEC # TBD
5	X-PT-5	LATEX PAINT FINISH	TBD	PRIMER + 2 COATS OF FINISH	BENJAMIN MOORE OR EQUAL		FINAL COLOR SPEC # TBD
6	X-PT-6	LATEX PAINT FINISH	TBD	PRIMER + 2 COATS OF FINISH	BENJAMIN MOORE OR EQUAL		FINAL COLOR SPEC # TBD
GLA	ASS / ACRYLIC SCHED	ULE					
NO.	EXHIBIT FINISH CODE	DESCRIPTION	COLOR	SPEC	SUPPLIER	CONTACT/ REP	COMMENTS
1	X-IGL-1	CLEAR GLASS		CLEAR TEMPERED			POLISH EXPOSED EDGES
2	X-IGL-2	CLEAR GLASS		LAMINATED ANNEALED			POLISH EXPOSED EDGES, HARDWARE AS SPEC'D ON DRAWINGS
3		01.548.4083/1.10		P30 BONDING			
٦	X-AC-1	CLEAR ACRYLIC		P 30 BONDING			
	X-AC-1 APHIC OUTPUT SCHED			F 30 BONDING			
GRA		ULE	SPEC	F30 BONDING	SUPPLIER	CONTACT/ REP	COMMENTS
GRA	APHIC OUTPUT SCHED	ULE	1" EASED EDGE F	PANELS @ RAILS, ID WHEELS, & " PAPERSTONE BACKING @ FOC		CONTACT/ REP	COMMENTS GRAPHIC RAILS & TABLETOPS
GRA NO.	APHIC OUTPUT SCHED EXHIBIT FINISH CODE X-GR-1	ULE DESCRIPTION IZONE OR	1" EASED EDGE F TABLETOPS; 1/4 PANELS & ID LAE	PANELS @ RAILS, ID WHEELS, & " PAPERSTONE BACKING @ FOC		CONTACT/ REP	
GRANO.	APHIC OUTPUT SCHED EXHIBIT FINISH CODE X-GR-1 X-DP-1	ULE DESCRIPTION IZONE OR FOLIA, CASHMERE FINISH EVERGREEN FABRIC JET TEX	1" EASED EDGE F TABLETOPS; 1/4 PANELS & ID LAE	PANELS @ RAILS, ID WHEELS, & " PAPERSTONE BACKING @ FOC ELS		CONTACT/ REP	GRAPHIC RAILS & TABLETOPS
GRANO.	APHIC OUTPUT SCHED EXHIBIT FINISH CODE X-GR-1 X-DP-1	ULE DESCRIPTION IZONE OR FOLIA, CASHMERE FINISH EVERGREEN FABRIC JET TEX OR FIRESAFE	1" EASED EDGE F TABLETOPS; 1/4 PANELS & ID LAE	PANELS @ RAILS, ID WHEELS, & " PAPERSTONE BACKING @ FOC ELS		CONTACT/ REP	GRAPHIC RAILS & TABLETOPS PHOTOMURALS & IMAGES

UTAH MUSEUM OF NATURAL HISTORY

UNIVERSITY OF UTAH, SALT LAKE CITY, UTAH

Owner
UMNH 1390 East President's Circle Salt Lake City, Utah 84112 801.581.6927 tel.

Design Architect

Architect of Record

Structural Engineer

Mechanical/Plumbing/FP Engineer Leslie E. Robertson Associates 30 Broad Street New York, New York 10004 212.750.9000 tel. Colvin Engineering Associates, Inc. 244 West 300 North Salt Lake City, Utah 84103 801.322.2400 tel Electrical/AV Engineer Spectrum Engineers 175 South Main Street Salt Lake City, Utah 84111 800.678.7077 tel Landscape Architect

BBI Engineering, Inc. 241 Quint Street San Francisco, CA 94124 415 685 9555 tel. Ralph Appelbaum Associates 88 Pine Street New York, New York 10005 212.334.8200 tel.



Key Plan


١		June 2, 2008
4	XG 60% CD	
	WS9	March. 26, 2008
	WS8	Feb. 20, 2008
	WS7	Dec. 18, 2007
	50% DD	Sept. 18, 2007
	WS6	July 11, 2007
	WS5	May 23, 2007

April 12, 2007 No. / Issue Name / Date

No. / Issue Name / Date

Symbols & Abbreviations Date Project No. 0275 June 2, 2008 Scale* Sheet No. X0-00-0.01


*Note: Scale Given for Full Size Drawing Sheet (22" x 34")

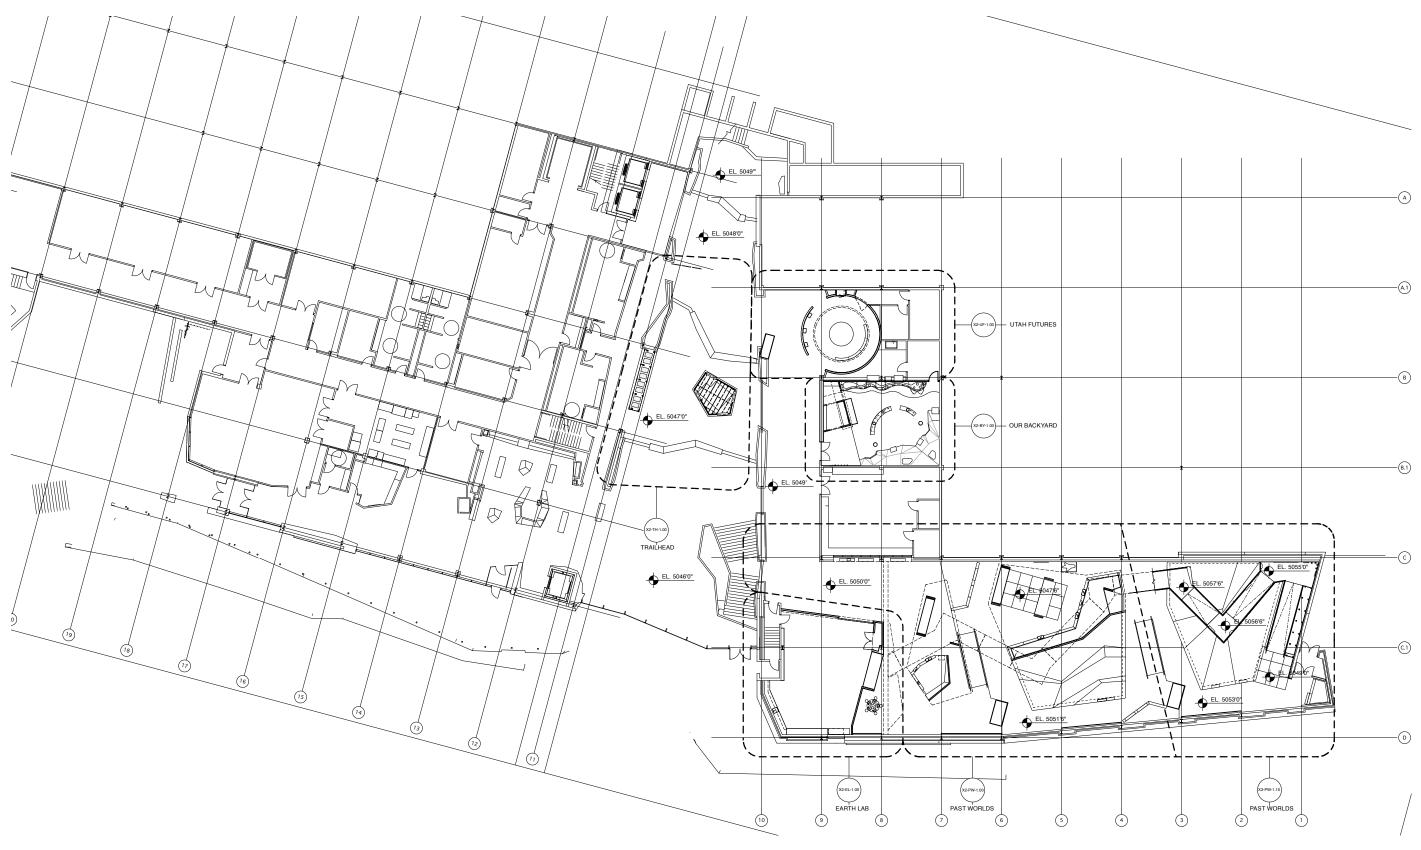

UNIVERSITY OF UTAH, SALT LAKE CITY, UTAH

BBI Engineering, Inc. 241 Quint Street 88 Pine Street New York, New York 10005 212.334.8200 tel.

Exhibit Construction

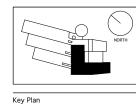


	FD WS2rev	Sept.22, 2008
	FD WS2	Sept.9, 2008
	100% DD	June 2, 2008
	XG 60% CD	
	WS9	March. 26, 2008
	WS8	Feb. 20, 2008
	WS7	Dec. 18, 2007
	50% DD	Sept. 18, 2007
	WS6	July 11, 2007
	WS5	May 23, 2007
_	WS4	April 12, 2007

No. / Issue Name / Date

		Sheet
		 Date
		Dec. 1
80% FD FD WS4	Dec.19, 2008 Nov.18, 2008	Scale*
FD WS3	Oct.16, 2008	 1/16"=

et Title vel 2 Plan . 19, 2008 X2-L2-0.00

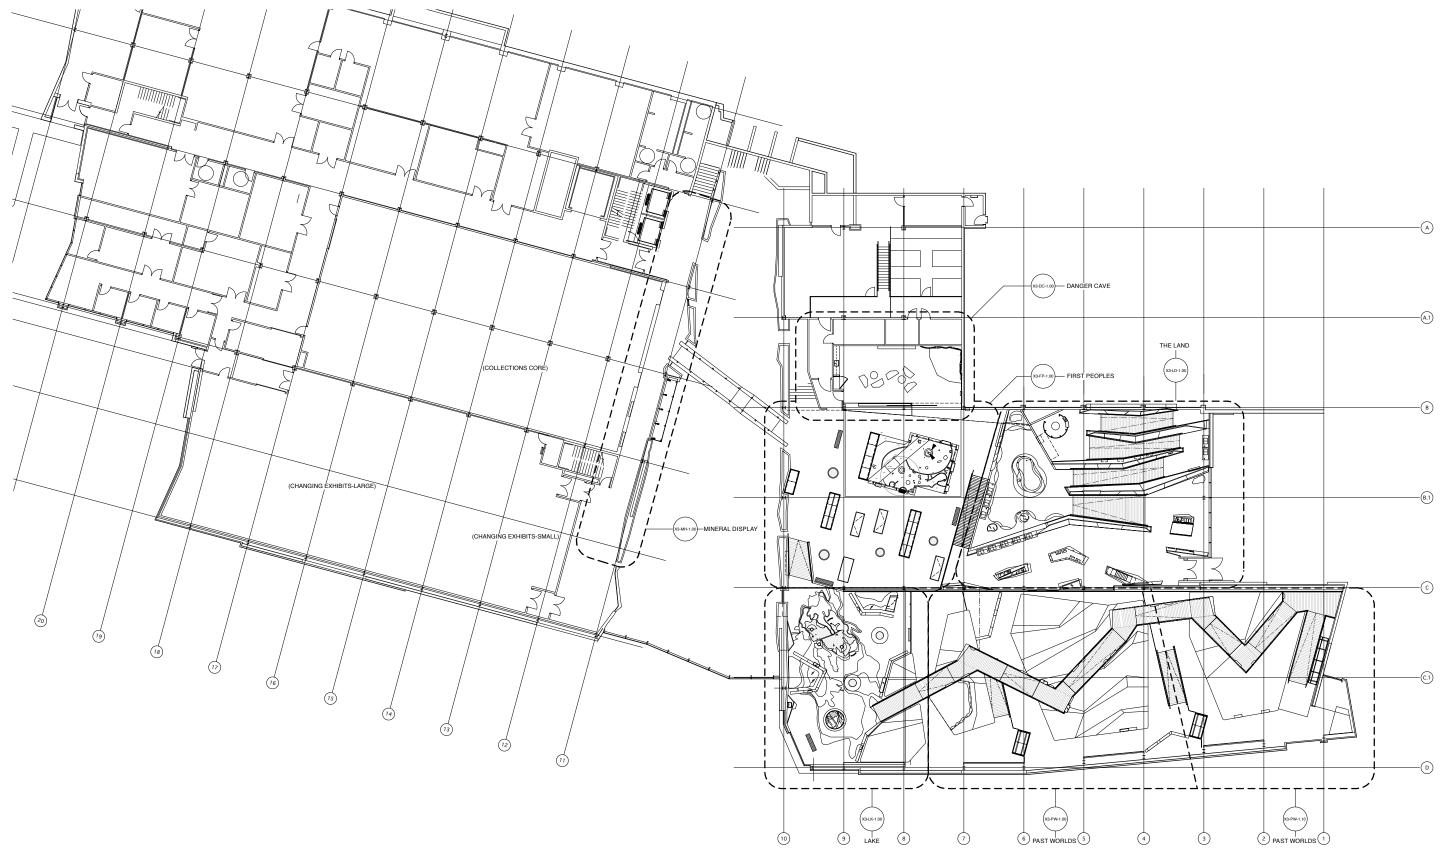


UNIVERSITY OF UTAH, SALT LAKE CITY, UTAH

Leslie E. Robertson Associates 30 Broad Street New York, New York 10004 212.750.9000 tel.

BBI Engineering, Inc. 241 Quint Street 88 Pine Street New York, New York 10005 212.334.8200 tel.


Exhibit Construction

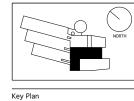

	FD WS2rev	Sept.22, 2008
1	FD WS2	Sept.9, 2008
	100% DD	June 2, 2008
	XG 60% CD	
	WS9	March. 26, 2008
	WS8	Feb. 20, 2008
	WS7	Dec. 18, 2007
	50% DD	Sept. 18, 2007
	WS6	July 11, 2007
	WS5	May 23, 2007
	WS4	April 12, 2007


No. / Issue Name / Date

	Sheet Title Level 3 Plan	
	Date	Project No.
	Dec. 19, 2008	0275
80% FD Dec.19, 2008 FD WS4 Nov.18, 2008 FD WS3 Oct.16, 2008	Scale* 1/16"=1'-0"	Sheet No. X3-L3-0.00
No. / Issue Name / Date		A3-L3-0.00

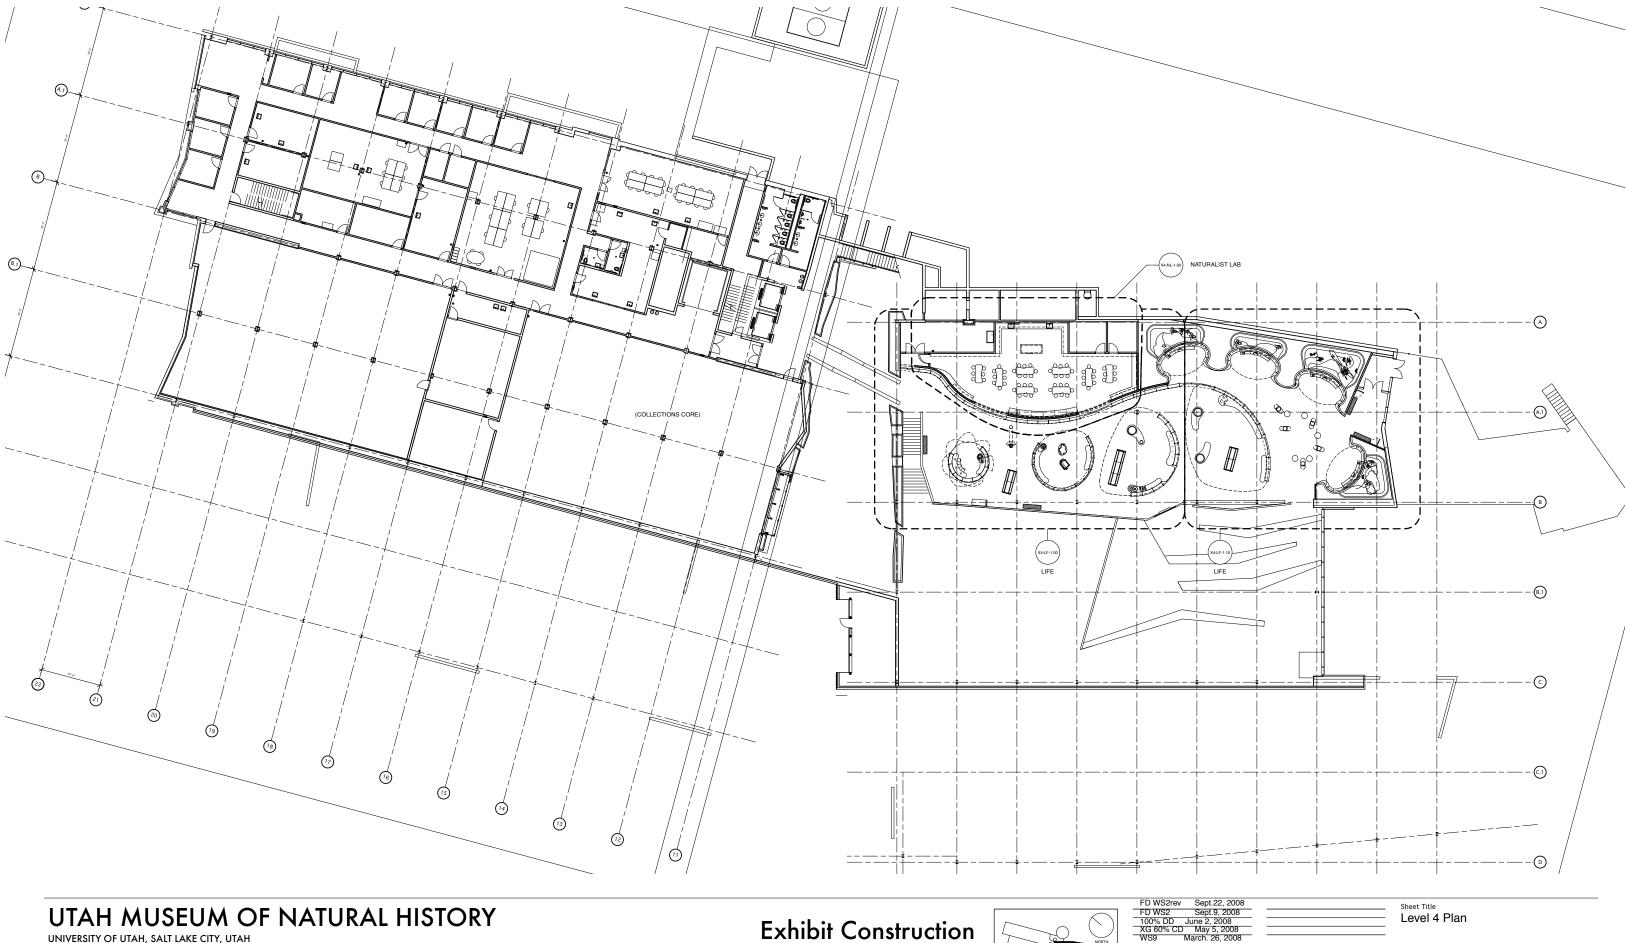


UNIVERSITY OF UTAH, SALT LAKE CITY, UTAH

BBI Engineering, Inc. 241 Quint Street 88 Pine Street New York, New York 10005 212.334.8200 tel.

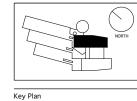

FD WS2	Sept.9, 2008
100% DD	June 2, 2008
	May 5, 2008
WS9	March. 26, 2008
WS8	Feb. 20, 2008
WS7	Dec. 18, 2007
50% DD	Sept. 18, 2007
WS6	July 11, 2007
WS5	May 23, 2007
WS4	April 12, 2007


Dec. 19, 2008 X4-L4-0.00

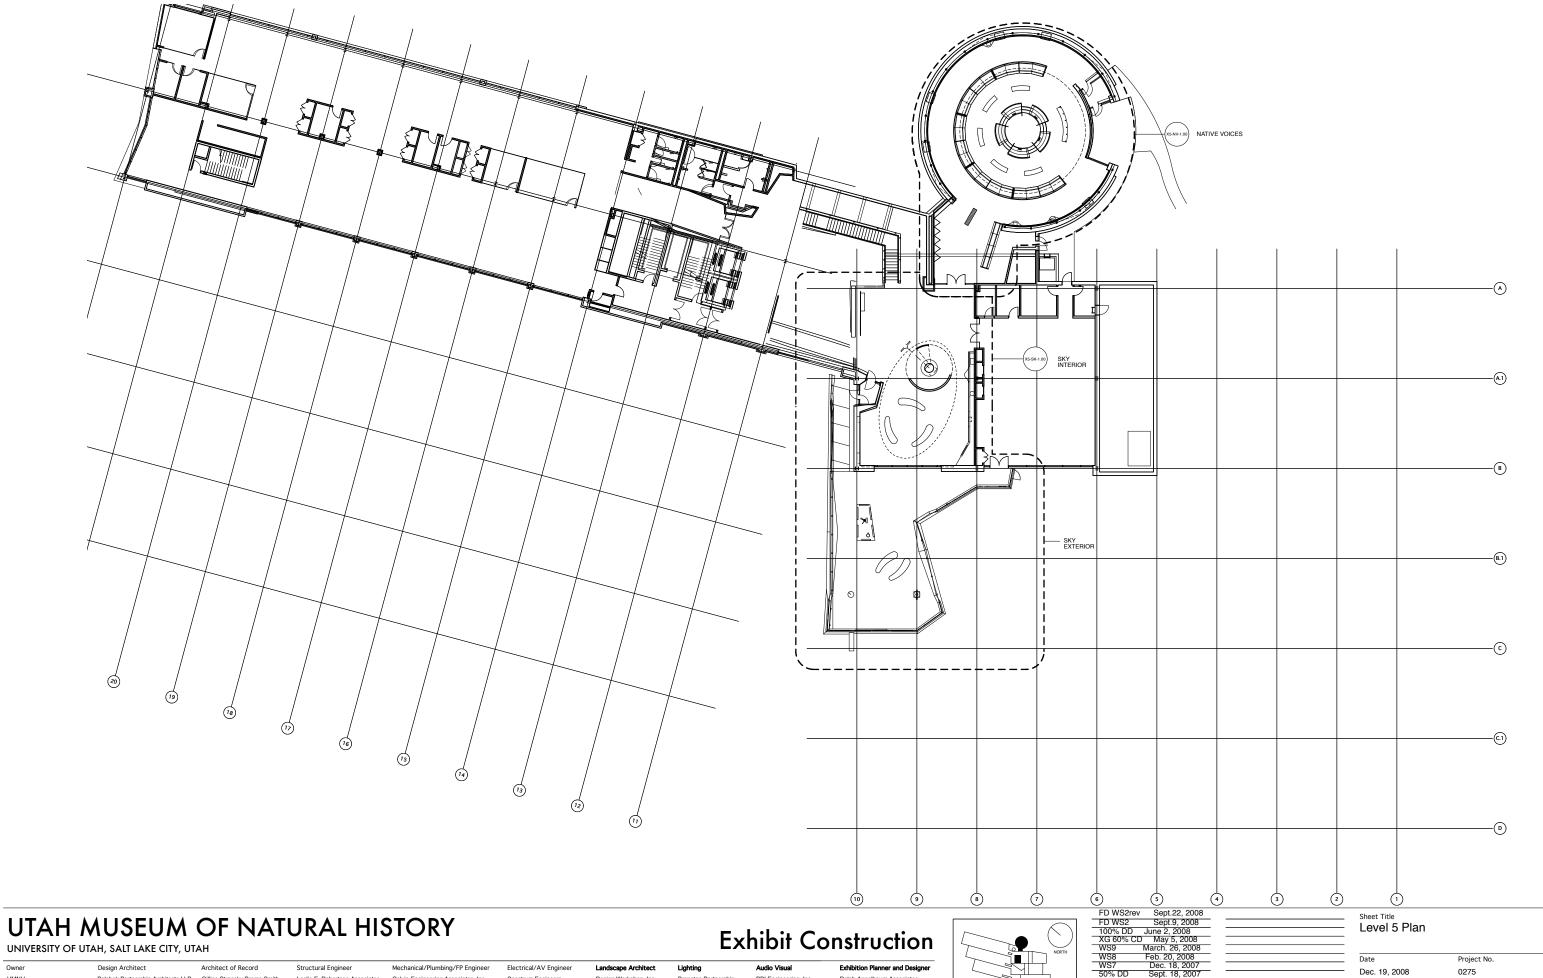

UNIVERSITY OF UTAH, SALT LAKE CITY, UTAH

Leslie E. Robertson Associates 30 Broad Street New York, New York 10004 212.750.9000 tel.


BBI Engineering, Inc.
241 Quint Street
San Francisco, CA 94124
415 685 9555 iel.
Ralph Appelbaum Associates
88 Pine Street
New York, New York 10005
212.3334.6200 tel.

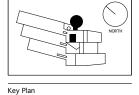

No. / Issue Name / Date

FD WS4 Nov.18, 2008 FD WS3 Oct.16, 2008 1/16"=1'-0"

X5-L5-0.00

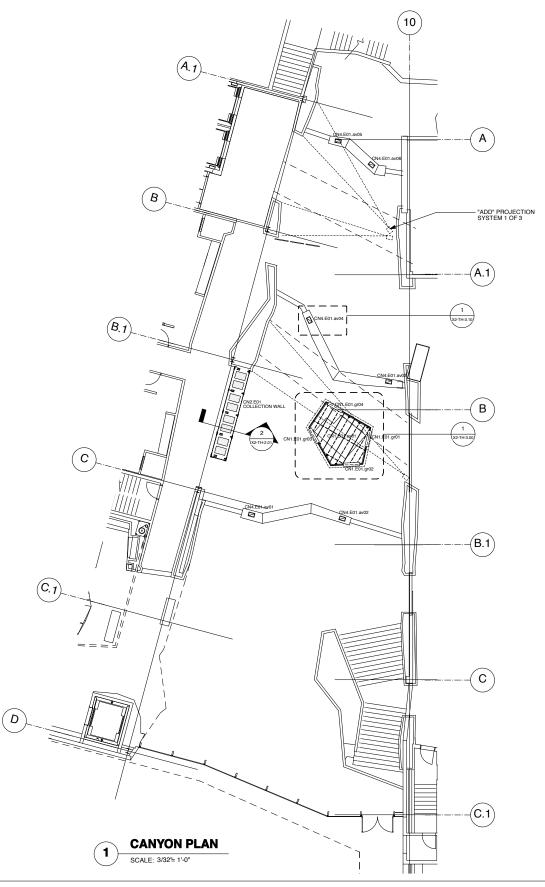

COLLECTION WALL AND CANYON FURNISHINGS IN BASE BUILDING SCOPE.


UTAH MUSEUM OF NATURAL HISTORY

UNIVERSITY OF UTAH, SALT LAKE CITY, UTAH

Electrical/AV Engineer

BBI Engineering, Inc. 241 Quint Street San Francisco, CA 94124 415 685 9555 tel. Ralph Appelbaum Associates 88 Pine Street New York, New York 10005 212.334.8200 tel.

Exhibit Construction

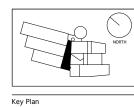


	FD WS2rev Sept.22, 2008
٦	FD WS2 Sept.9, 2008
Л	100% DD June 2, 2008
1	XG 60% CD May 5, 2008
1	WS9 March. 26, 2008
	WS8 Feb. 20, 2008
1	WS7 Dec. 18, 2007
	50% DD Sept. 18, 2007
	WS6 July 11, 2007 WS5 May 23, 2007
	WS5 May 23, 2007
_	WS4 April 12 2007

No. / Issue Name / Date

80% FD Dec.19, 2008 FD WS4 Nov.18, 2008 FD WS3 Oct.16, 2008 No. / Issue Name / Date

Sheet Title Level 2 Partial Plan: Trailhead Project No. 0275 Dec. 19, 2008 X2-TH-1.00

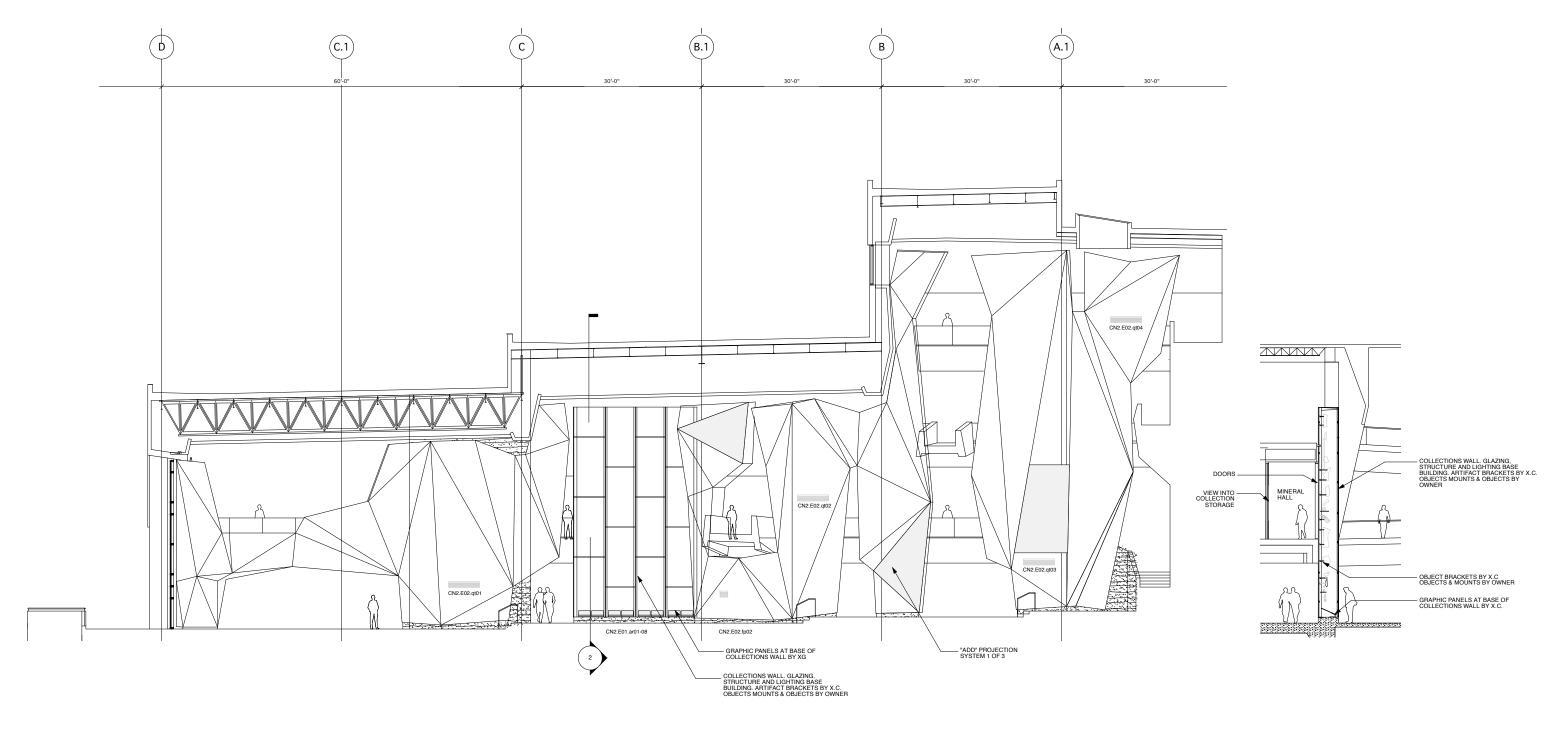

CANYON SECTION LOOKING NORTH

CANYON SECTION SCALE: 1/8" = 1'-0"

UTAH MUSEUM OF NATURAL HISTORY

SCALE: 1/8" = 1'-0"

UNIVERSITY OF UTAH, SALT LAKE CITY, UTAH

Structural Engineer


Mechanical/Plumbing/FP Engineer Leslie E. Robertson Associates 30 Broad Street New York, New York 10004 212.750.9000 tel. Colvin Engineering Associates, Inc. 244 West 300 North Salt Lake City, Utah 84103 801.322.2400 tel Electrical/AV Engineer Spectrum Engineers 175 South Main Street Salt Lake City, Utah 84111 800.678.7077 tel

Landscape Architect

Lighting

BBI Engineering, Inc. 241 Quint Street San Francisco, CA 94124 415 685 9555 tel. Ralph Appelbaum Associates 88 Pine Street New York, New York 10005 212.334.8200 tel.

Exhibit Construction

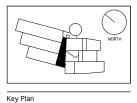

FD WS2rev Sept.22, 2008 FD WS2 Sept.22, 2008

FD WS2 Sept.9, 2008

100% DD June 2, 2008

XG 60% CD May 5, 2008

WS9 March. 26, 2008

No. / Issue Name / Date


FD WS4 Nov.18, 2008 FD WS3 Oct.16, 2008

No. / Issue Name / Date

Level 2 Sections & Elevations: Trailhead Date Project No.

0275 Dec. 19, 2008 Sheet No.

X2-TH-2.00

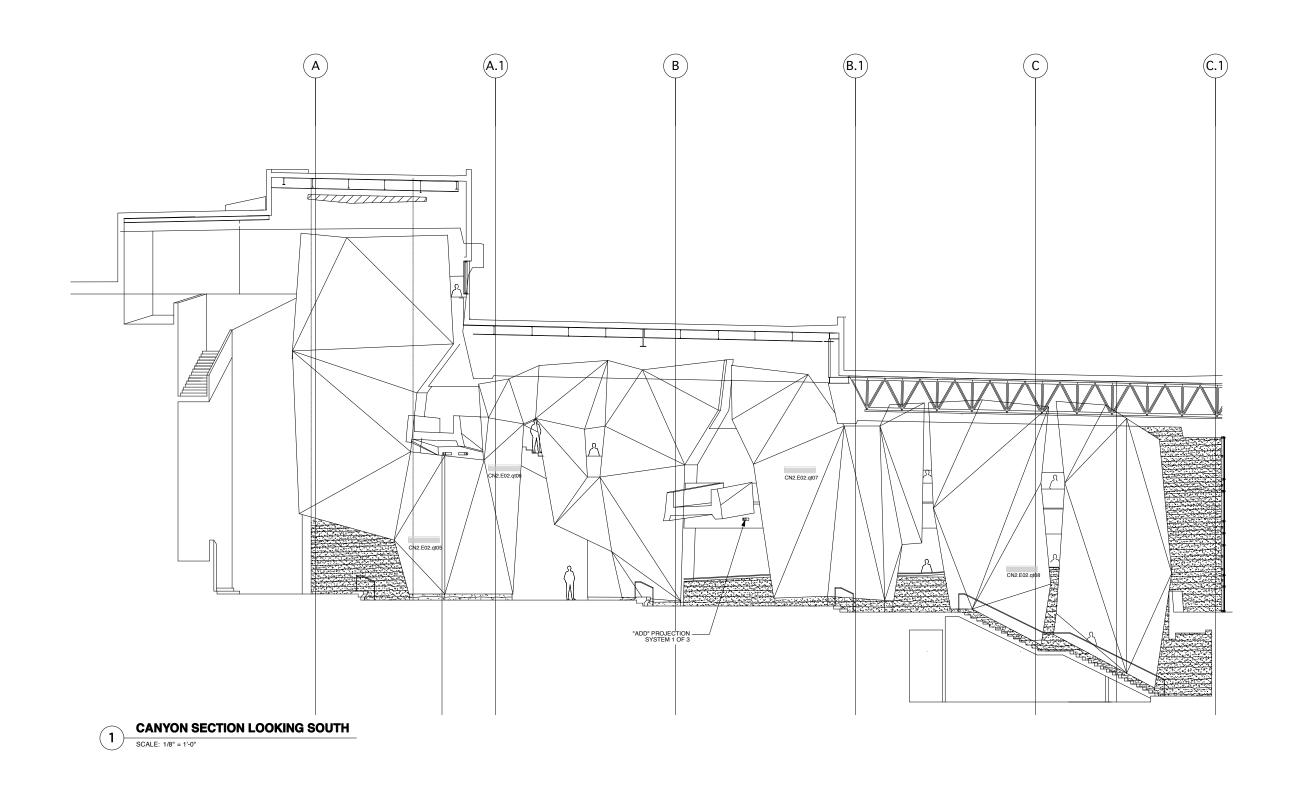

UNIVERSITY OF UTAH, SALT LAKE CITY, UTAH

BBI Engineering, Inc. 241 Quint Street San Francisco, CA 94124 415 685 9555 tel.



	FD WS2rev	Sept.22, 2008
	FD WS2	Sept.9, 2008
١l	100% DD	June 2, 2008
/	XG 60% CD	
	WS9	March. 26, 2008
	WS8	Feb. 20, 2008
	WS7	Dec. 18, 2007
	50% DD	Sept. 18, 2007
	WS6	July 11, 2007
	WS5	May 23, 2007
	WS4	April 12, 2007


No. / Issue Name / Date


No. / Issue Name / Date

Sheet Title
Level 2 Elevations: Trailhead

Project No Dec. 19, 2008

X2-TH-2.01 *Note: Scale Given for Full Size Drawing Sheet (22" x 34")

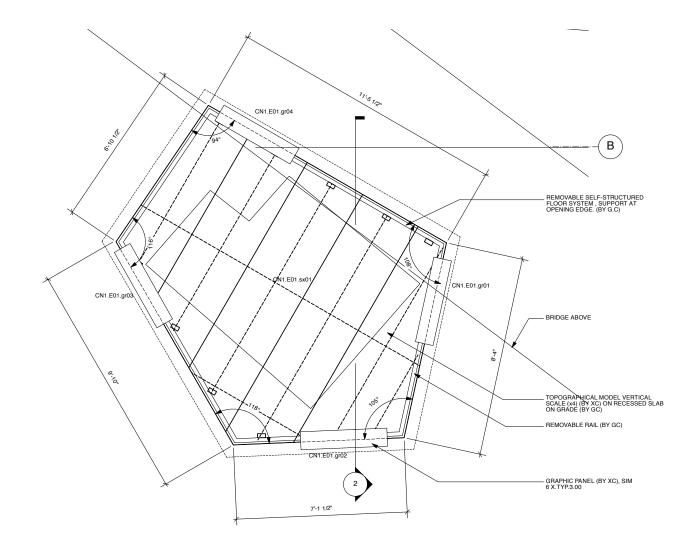

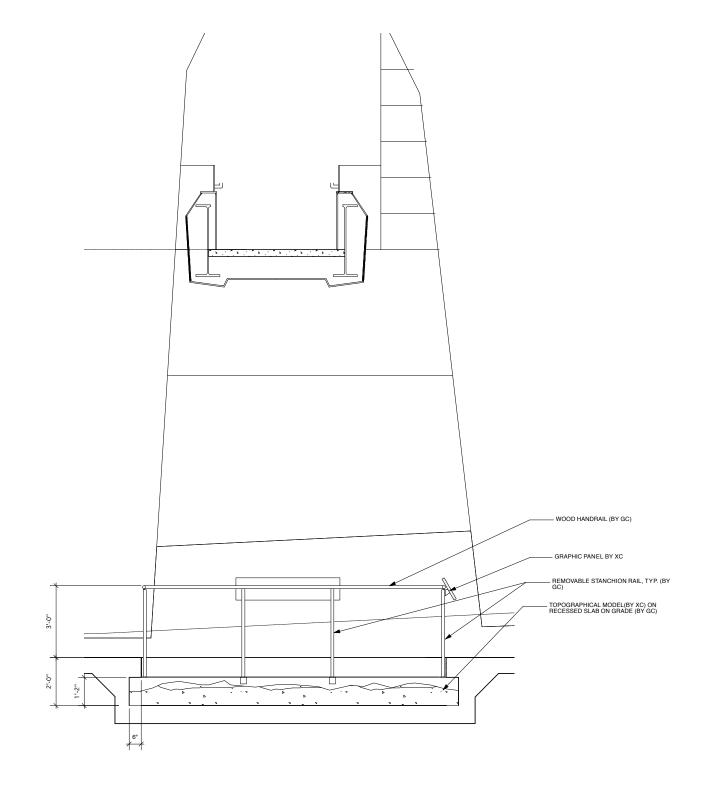

PLAN UTAH TOPO. MAP SCALE: 1/2" = 1'-0"

CANYON SECTION LOOKING SOUTH

UTAH MUSEUM OF NATURAL HISTORY

UNIVERSITY OF UTAH, SALT LAKE CITY, UTAH

Owner
UMNH 1390 East President's Circle Salt Lake City, Utah 84112 801 581 6927 tel


Leslie E. Robertson Associates 30 Broad Street New York, New York 10004 212.750.9000 tel. Color Education Sait Lake City, Utah 84103 901.322.2400 tel

Electrical/AV Engineer Spectrum Engineers 175 South Main Street Salt Lake City, Utah 84111 800.678.7077 tel

Branston Partnership 122 West 26th Street New York, NY 10001 212.924.4050 tel.

BBI Engineering, Inc. 241 Quint Street 88 Pine Street 88 Pine Street 40 New York, New York 10005 212.334.8200 tel.

Exhibit Construction

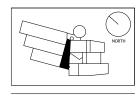


I D WOZIEV	3ept.22, 2000
FD WS2	Sept.9, 2008
100% DD	June 2, 2008
XG 60% CL	
WS9	March. 26, 2008
WS8	Feb. 20, 2008
WS7	Dec. 18, 2007
50% DD	Sept. 18, 2007
WS6	July 11, 2007
WS5	May 23, 2007
WS4	April 12, 2007

No. / Issue Name / Date

	Sheet Title Level 2 Detail Trailhead Top	
	Date	Project No.
	Dec. 19, 2008	0275
80% FD Dec.19, 2008 FD WS4 Nov.18, 2008	Scale*	Sheet No.
FD WS3 Oct.16, 2008	As Noted	Y2-TL
		~ ~ - I I

No. / Issue Name / Date

X2-TH-3.00

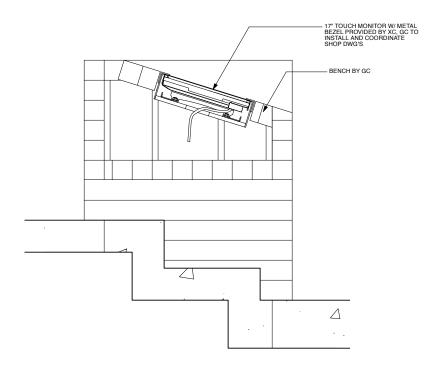

TYP. SECTION DETAIL: TRAILHEAD MONITOR SCALE: 1-1/2" = 1'-0"

UTAH MUSEUM OF NATURAL HISTORY

UNIVERSITY OF UTAH, SALT LAKE CITY, UTAH

Design Architect

Polshek Partnership Architects LLP 320 West 13th Street New York, New York 212.807.7171 tel. Gillies Stransky Brems Smith 375 West 200 South Salt Lake City, Utah 901.521.8600 tel.

Architect of Record

Structural Engineer Leslie E. Robertson Associates 30 Broad Street New York, New York 10004 212.750.9000 tel.

Mechanical/Plumbing/FP Engineer Colvin Engineering Associates, Inc. 244 West 300 North Salt Lake City, Utah 84103 801.322.2400 tel

Electrical/AV Engineer Spectrum Engineers 175 South Main Street Salt Lake City, Utah 84111 800.678.7077 tel


Landscape Architect

Branston Partnership 122 West 26th Street New York, NY 10001 212.924.4050 tel.

BBI Engineering, Inc. 241 Quint Street San Francisco, CA 94124 415 685 9555 tel.

Exhibit Construction Exhibition Planner and Designer

Key Plan

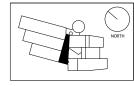

< 1	100% DD	June 2, 2008
- /		D May 5, 2008
IORTH	WS9	March. 26, 2008
	WS8	Feb. 20, 2008
	WS7	Dec. 18, 2007
	50% DD	Sept. 18, 2007
	WS6	July 11, 2007
	WS5	May 23, 2007
	WS4	April 12, 2007


FD WS2rev Sept.22, 2008 FD WS2 Sept.9, 2008

Sheet Title
Level 2 Details: Trailhead Monitors Dec. 19, 2008 0275 Sheet No.

80% FD Dec.19, 2008 FD WS4 Nov.18, 2008 FD WS3 Oct.16, 2008 As Noted

No. / Issue Name / Date *Note: Scale Given for Full Size Drawing Sheet (22" x 34")

X2-TH-3.10

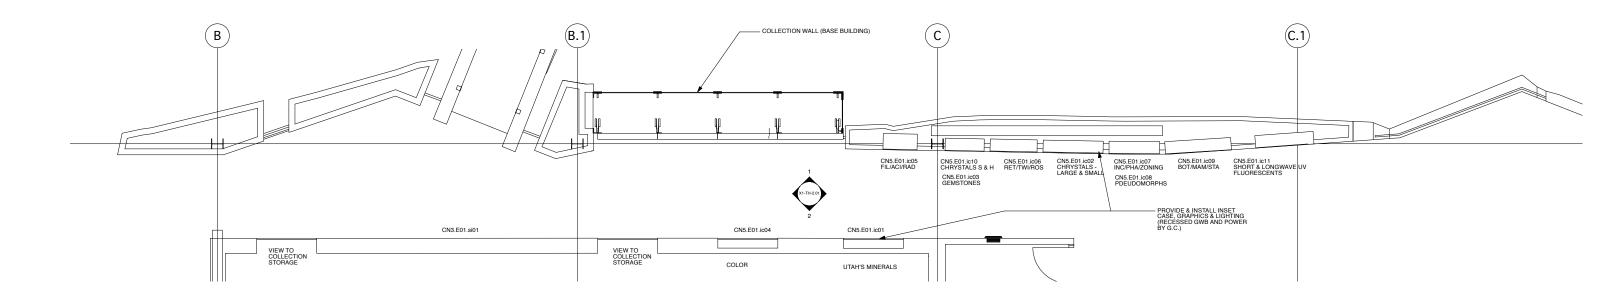



UNIVERSITY OF UTAH, SALT LAKE CITY, UTAH

Structural Engineer Leslie E. Robertson Associates 30 Broad Street New York, New York 10004 212.750.9000 tel.

Electrical/AV Engineer

BBI Engineering, Inc. 241 Quint Street San Francisco, CA 94124 415 685 9555 tel.

Ralph Appelbaum Associates 88 Pine Street New York, New York 10005 212.334.8200 tel.




FD WS2rev Sept.22, 2008 FD WS2 Sept.9, 2008
100% DD June 2, 2008
XG 60% CD May 5, 2008
WS9 March. 26, 2008


No. / Issue Name / Date

80% FD Dec.19, 2008 FD WS4 Nov.18, 2008 FD WS3 Oct.16, 2008 No. / Issue Name / Date

Sheet Title Level 3 Partial Plan: Mineral Hall Date Project No. 0275 Dec. 19, 2008 Sheet No. X3-MH-1.00

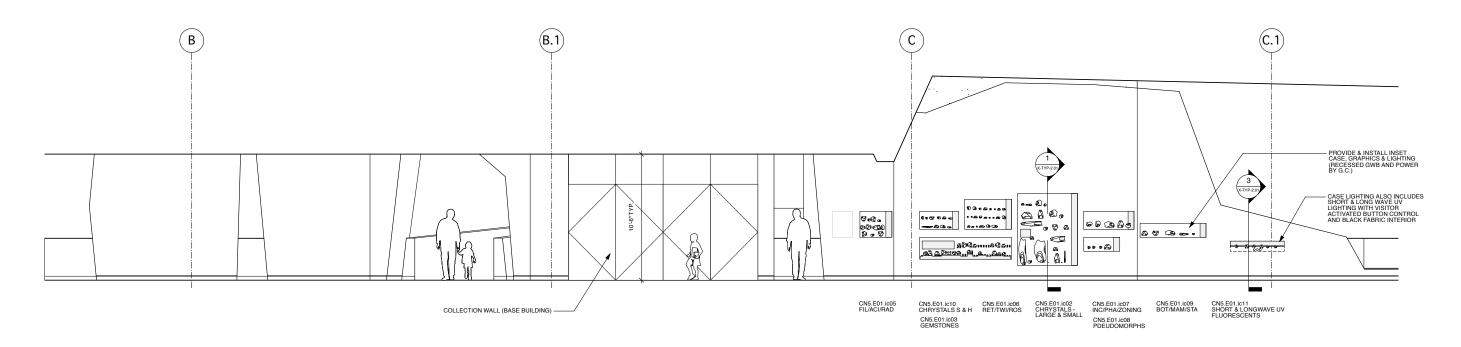

MINERAL HALL SECTION LOOKING SOUTH

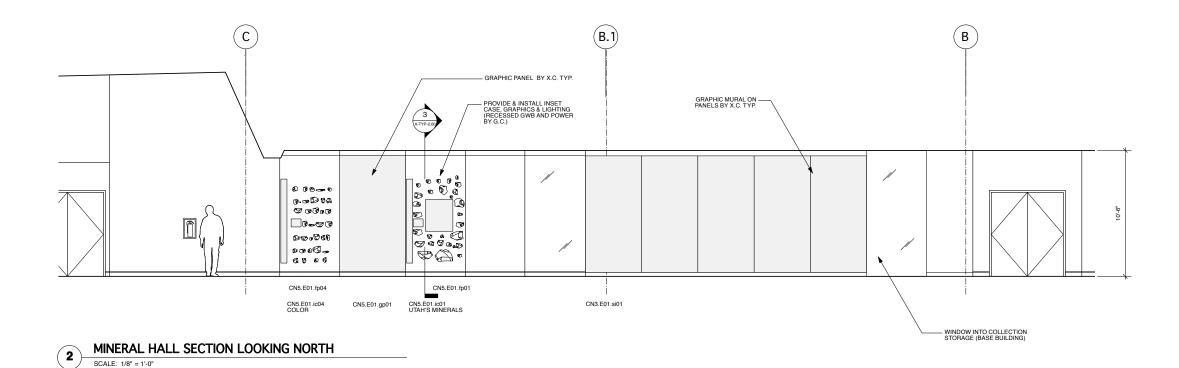

UTAH MUSEUM OF NATURAL HISTORY

UNIVERSITY OF UTAH, SALT LAKE CITY, UTAH

Structural Engineer Leslie E. Robertson Associates 30 Broad Street New York, New York 10004 212.750.9000 tel.

Mechanical/Plumbing/FP Engineer Colvin Engineering Associates, Inc. 244 West 300 North Salt Lake City, Utah 84103 801.322.2400 tel Electrical/AV Engineer Spectrum Engineers 175 South Main Street Salt Lake City, Utah 84111 800.678.7077 tel

Landscape Architect

Lighting

BBI Engineering, Inc. 241 Quint Street San Francisco, CA 94124 415 685 9555 tel. Ralph Appelbaum Associates 88 Pine Street New York, New York 10005 212.334.8200 tel.




	FD WS2rev	Sept.22, 2008
$\overline{}$	FD WS2	Sept.9, 2008
、	100% DD	June 2, 2008
	XG 60% CD	
ORTH	WS9	March. 26, 2008
JIX.III	WS8	Feb. 20, 2008
	WS7	Dec. 18, 2007
	50% DD	Sept. 18, 2007
	WS6	July 11, 2007 May 23, 2007
	WS5	
	WS4	April 12, 2007

No. / Issue Name / Date

Sheet Title
Level 3 Sections & Elevations: Mineral Hall Project No. 0275 Dec. 19, 2008 80% FD Dec.19, 2008 FD WS4 Nov.18, 2008 FD WS3 Oct.16, 2008 Sheet No.

No. / Issue Name / Date

X3-MH-2.00

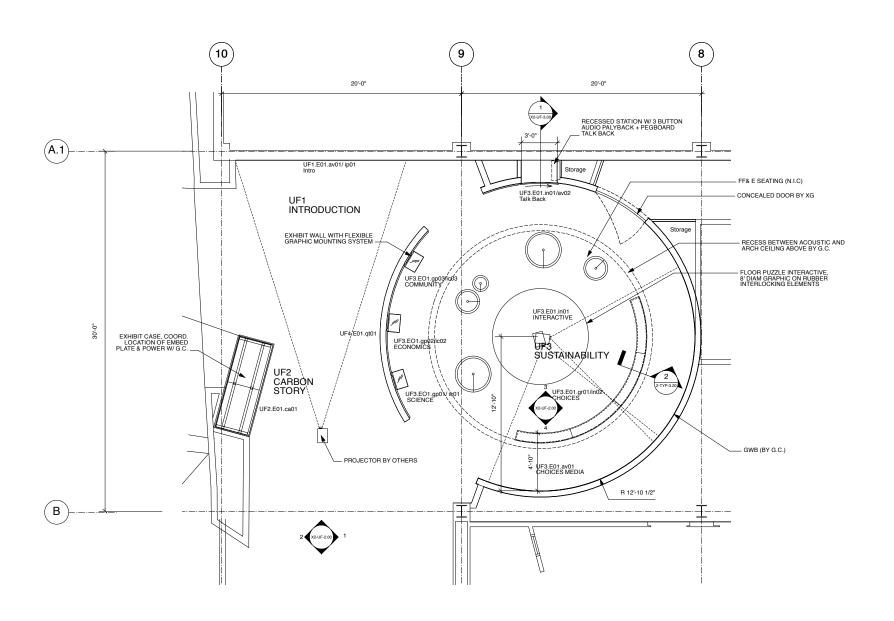

UNIVERSITY OF UTAH, SALT LAKE CITY, UTAH

Leslie E. Robertson Associates 30 Broad Street New York, New York 10004 212.750.9000 tel.

Audio Visual

BBI Engineering, Inc.
241 Quint Street
San Francisco, CA 94124
145 685 9555 fel.

Engineering, Inc.
88 Pine Street
88 Pine Street
145 864 9555 fel.
212.334 8200 tel.




	FD WS2rev	Sept.22, 2008
	FD WS2	Sept.9, 2008
71	100% DD	June 2, 2008
71	XG 60% CD	
		March. 26, 2008
	WS8	Feb. 20, 2008
	WS7	Dec. 18, 2007
	50% DD	Sept. 18, 2007
	WS6	July 11, 2007
	WS5	May 23, 2007
	WS4	April 12, 2007

No. / Issue Name / Date

No. / Issue Name / Date

Sheet Title Level 2 Partial Plan: Utah Futures Observatory/ Mineral Hall Dec. 19, 2008

X2-UF-1.00

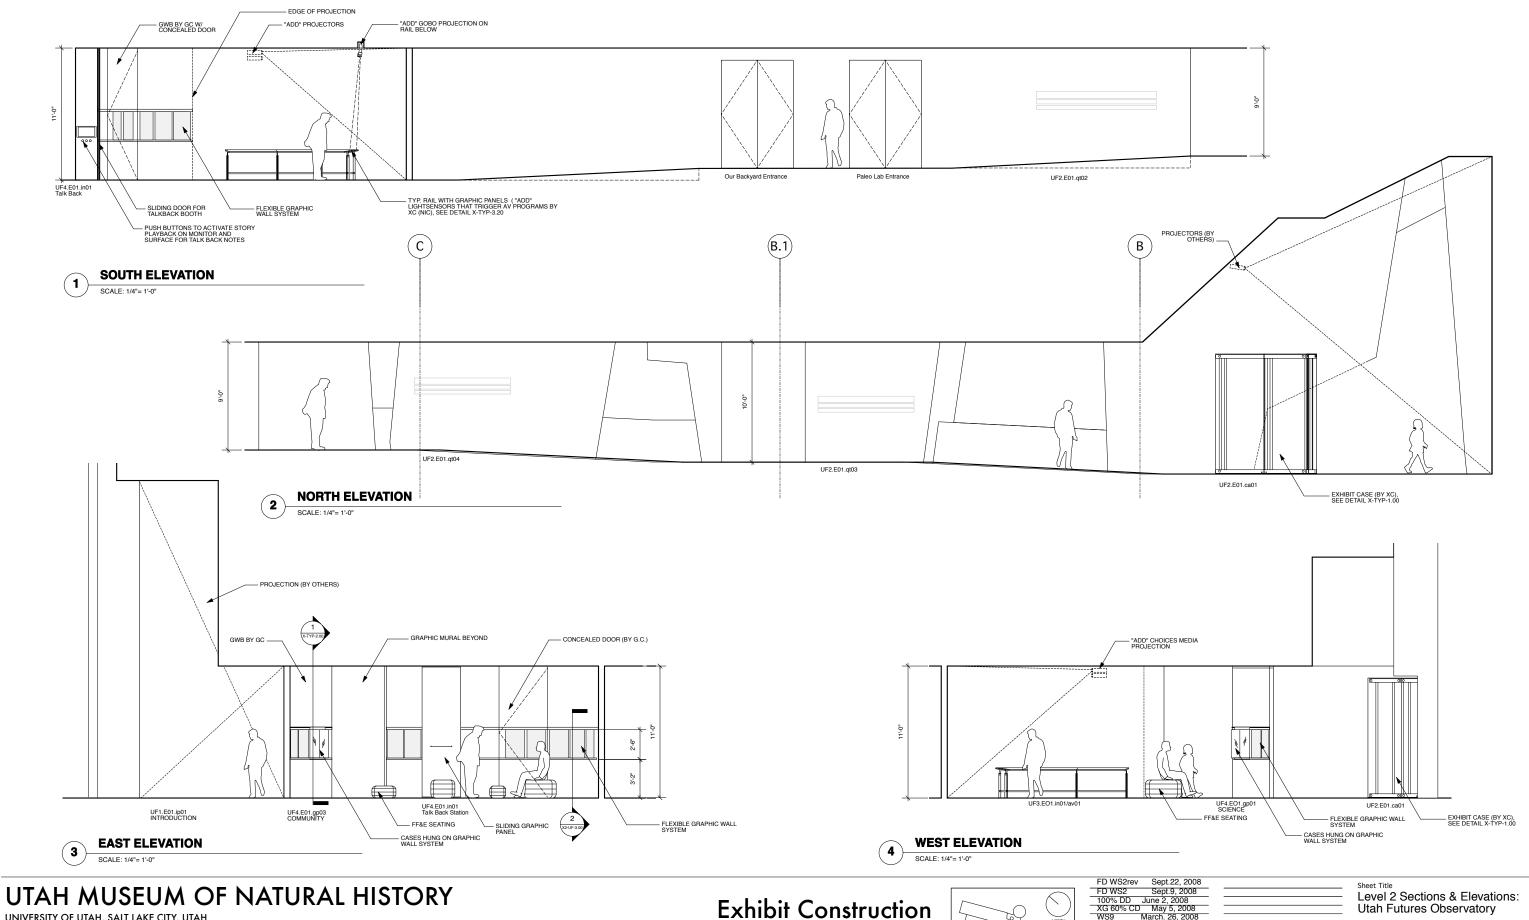

UNIVERSITY OF UTAH, SALT LAKE CITY, UTAH

Structural Engineer Leslie E. Robertson Associates 30 Broad Street New York, New York 10004 212.750.9000 tel. Colvin Engineering Associates, Inc. 244 West 300 North Salt Lake City, Utah 84103 801.322.2400 tel


Electrical/AV Engineer

Landscape Architect

Lighting


BBI Engineering, Inc. 241 Quint Street San Francisco, CA 94124 415 685 9555 tel.


Ralph Appelbaum Associates 88 Pine Street New York, New York 10005 212.334.8200 tel.

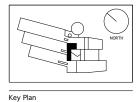

FD WS2rev	Sept.22, 2008
FD WS2	Sept.9, 2008
100% DD	June 2, 2008
XG 60% CD	
WS9	March. 26, 2008
WS8	Feb. 20, 2008
WS7	Dec. 18, 2007
50% DD	Sept. 18, 2007
WS6	July 11, 2007
WS5	May 23, 2007
WS4	April 12, 2007
No. / Issue Nan	ne / Date

Sheet Title
Level 2 Sections & Elevations:
Utah Futures Observatory Dec. 19, 2008 80% FD Dec.19, 2008 FD WS4 Nov.18, 2008 FD WS3 Oct.16, 2008 Sheet No. X2-UF-2.00 No. / Issue Name / Date

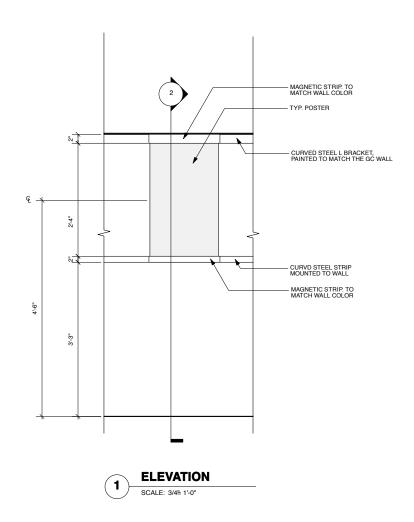

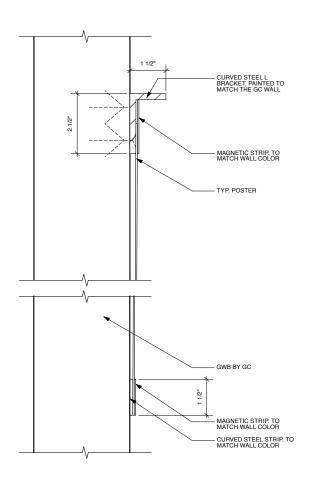

DETAIL SECTION SCALE: 1:2

UTAH MUSEUM OF NATURAL HISTORY

UNIVERSITY OF UTAH, SALT LAKE CITY, UTAH

Structural Engineer Leslie E. Robertson Associates 30 Broad Street New York, New York 10004 212.750.9000 tel.

Mechanical/Plumbing/FP Engineer Colvin Engineering Associates, Inc. 244 West 300 North Salt Lake City, Utah 84103 801.322.2400 tel Electrical/AV Engineer Spectrum Engineers 175 South Main Street Salt Lake City, Utah 84111 800.678.7077 tel Landscape Architect

Lighting

BBI Engineering, Inc. 241 Quint Street San Francisco, CA 94124 415 685 9555 tel.

Ralph Appelbaum Associates 88 Pine Street New York, New York 10005 212.334.8200 tel.



Key Plan

FD WS2rev Sept.22, 2008 FD WS2 Sept.9, 2008

100% DD June 2, 2008


XG 60% CD May 5, 2008


WS9 March. 26, 2008


No. / Issue Name / Date


Sheet Title
Level 2 Details: **Utah Futures Observatory** Date Project No. Dec. 19, 2008

80% FD Dec.19, 2008 FD WS4 Nov.18, 2008 FD WS3 Oct.16, 2008 Sheet No. X2-UF-3.00 No. / Issue Name / Date

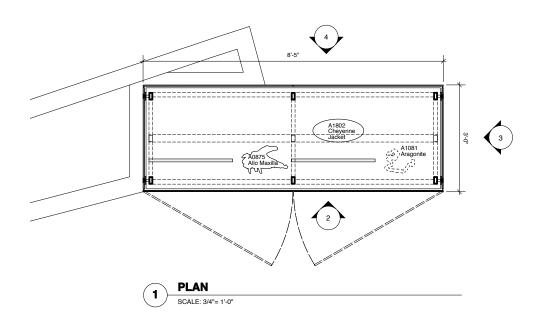

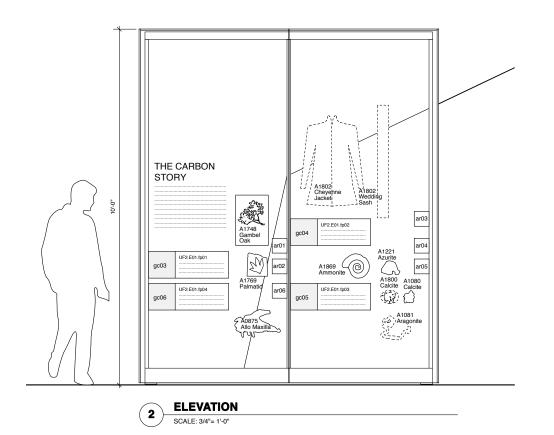

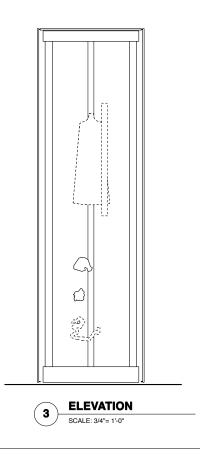

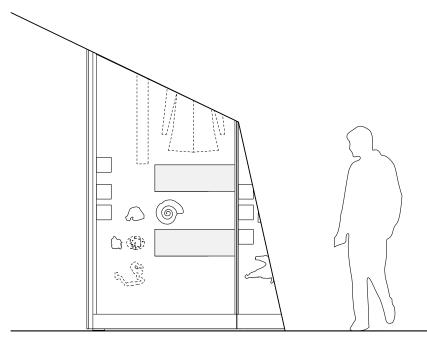



1. SEE X-TYP-1.00 FOR GLASS CASE SCHEDULE AND TYP. CASE DWGS FOR BRACKET & PANEL DTLS

2. SEE CASEWORK SPECIFICATIONS

UTAH MUSEUM OF NATURAL HISTORY

UNIVERSITY OF UTAH, SALT LAKE CITY, UTAH

0wner	Design Architect
UMNH 1390 East President's Circle	Polshek Partnership Architects LLP 320 West 13th Street

Leslie E. Robertson Associate 30 Broad Street New York, New York 10004 212.750.9000 tel.

Mechanical/Plumbing/FP Engineer Colvin Engineering Associates, Inc. 244 West 300 North Salt Lake City, Utah 84103 801.322.2400 tel

Lighting Branston Partnership 122 West 26th Street New York, NY 10001 212.924.4050 tel.

BBI Engineering, Inc. 241 Quint Street San Francisco, CA 94124 415 685 9555 tel.



FD WS2rev	Sept.22, 2008
FD WS2	Sept.9, 2008
100% DD	June 2, 2008
XG 60% CD	
WS9	March. 26, 2008
WS8	Feb. 20, 2008
WS7	Dec. 18, 2007
50% DD	Sept. 18, 2007
WS6	July 11, 2007
WS5	May 23, 2007
WS4	April 12, 2007

No. / Issue Name / Date

FD WS3 Oct.16, 2008 No. / Issue Name / Date


Sheet Title
Exhibit Case Layouts
UF2.E01.ca01 Date


Project No. 0275 Nov. 3, 2008 Sheet No. Scale*

X2-UF-5.10

*Note: Scale Given for Full Size Drawing Sheet (22" x 34")

3/4"=1'-0"

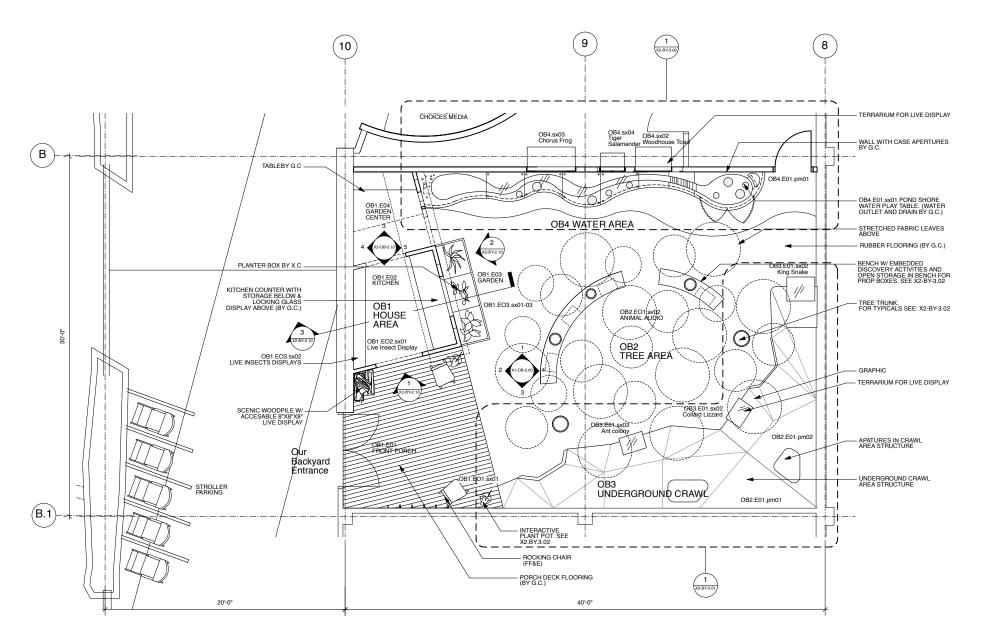

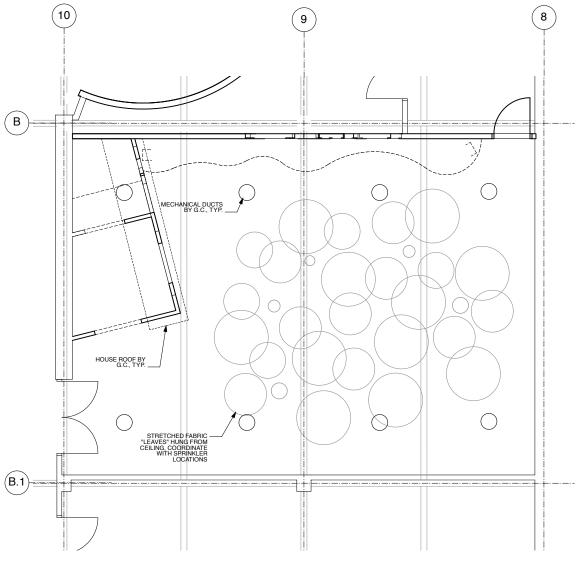

UNIVERSITY OF UTAH, SALT LAKE CITY, UTAH

Design Architect

Architect of Record

Leslie E. Robertson Associates 30 Broad Street New York, New York 10004 212.750.9000 tel.

Electrical/AV Engineer Spectrum Engineers 175 South Main Street Salt Lake City, Utah 84111 800.678.7077 tel

BBI Engineering, Inc. 241 Quint Street San Francisco, CA 94124 415 685 9555 tel.





FD W32IEV	3ept.22, 2006
FD WS2	Sept.9, 2008
100% DD	June 2, 2008
XG 60% CL	
WS9	March. 26, 2008
WS8	Feb. 20, 2008
WS7	Dec. 18, 2007
50% DD	Sept. 18, 2007
WS6	July 11, 2007
WS5	May 23, 2007
WS4	April 12, 2007


80% FD Dec.19, 2008 FD WS4 Nov.18, 2008 FD WS3 Oct.16, 2008


Sheet Title
Level 2 Partial Plan / RCP:
'Our Backyard'/Children's Gallery

Sheet No. X2-BY-1.00

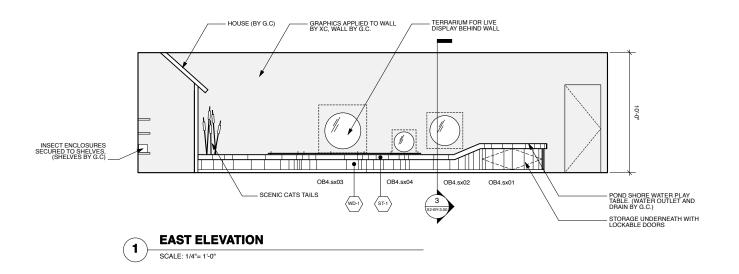

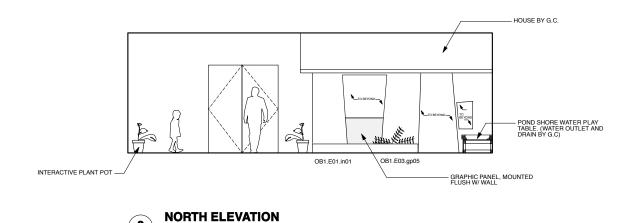

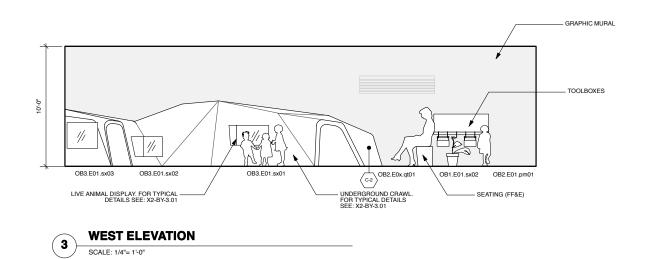

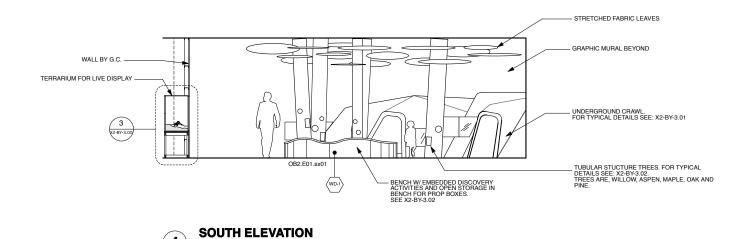

UNIVERSITY OF UTAH, SALT LAKE CITY, UTAH

Owner
UMNH 1390 East President's Circle Salt Lake City, Utah 84112 801.581.6927 tel.

Design Architect

Architect of Record Gillies Stransky Brems Smith 375 West 200 South Salt Lake City, Utah 801.521.8600 tel.

Structural Engineer Leslie E. Robertson Associates 30 Broad Street New York, New York 10004 212.750.9000 tel.

Mechanical/Plumbing/FP Engineer

Electrical/AV Engineer Spectrum Engineers 175 South Main Street Salt Lake City, Utah 84111 800.678.7077 tel Landscape Architect

BBI Engineering, Inc. 241 Quint Street San Francisco, CA 94124 415 685 9555 tel.



Key Plan

SCALE: 1/4"= 1'-0"

SCALE: 1/4"= 1'-0"

100% DD June 2, 2008 XG 60% CD May 5, 2008 WS4 April 12, 2007 Sheet Title
Level 2 Sections & Elevations:
'Our Backyard'/Children's Gallery June 2, 2008


Scale*

No. / Issue Name / Date

1/2"=1'-0"


Sheet No.

X2-BY-2.00

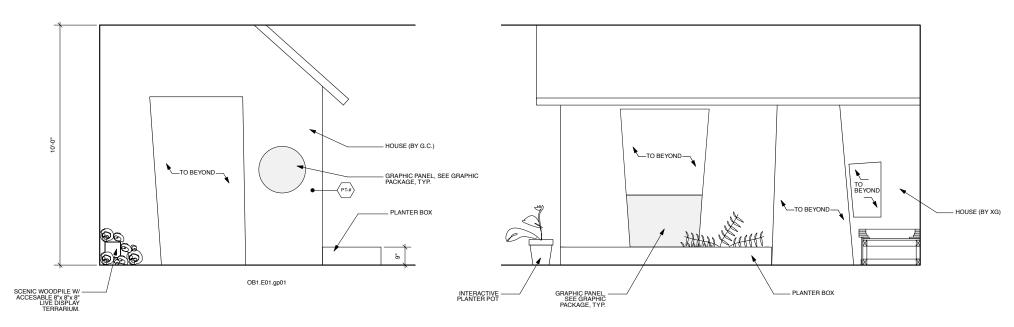


SOUTH ELEVATION: KITCHEN AREA SCALE: 1/2"= 1'-0"


NORTH ELEVATION: KITCHEN AREA

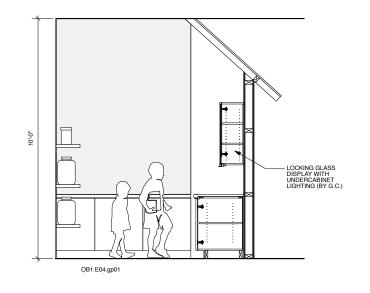



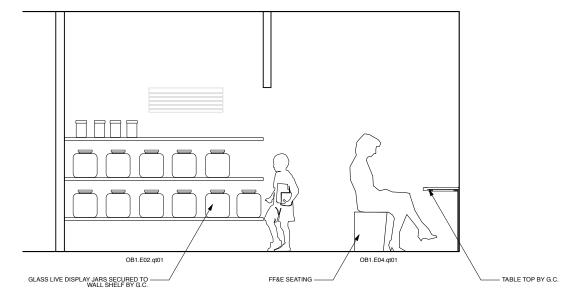

NORTH SECTION: KITCHEN AREA

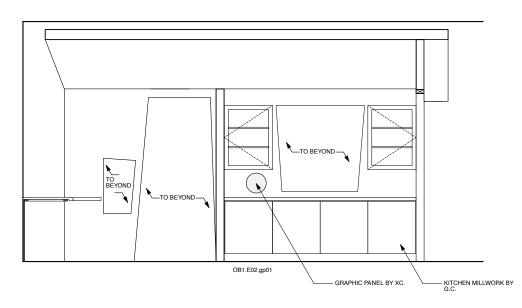

SOUTH SECTION: KITCHEN AREA

UTAH MUSEUM OF NATURAL HISTORY

UNIVERSITY OF UTAH, SALT LAKE CITY, UTAH

Owner
UMNH 1390 East President's Circle Salt Lake City, Utah 84112 801.581.6927 tel.

Design Architect

Architect of Record

Structural Engineer

Electrical/AV Engineer

BBI Engineering, Inc. 241 Quint Street San Francisco, CA 94124 415 685 9555 tel.




100% DD	June 2, 2008
XG 60% CI	
WS9	March. 26, 2008
WS8	Feb. 20, 2008
WS7	Dec. 18, 2007
50% DD	Sept. 18, 2007
WS6	July 11, 2007
WS5	May 23, 2007
WS4	April 12 2007

June 2, 2008

Sheet Title
Level 2 Sections & Elevations:
'Our Backyard' House Area Sheet No.

X2-BY-2.10 *Note: Scale Given for Full Size Drawing Sheet (22" x 34")

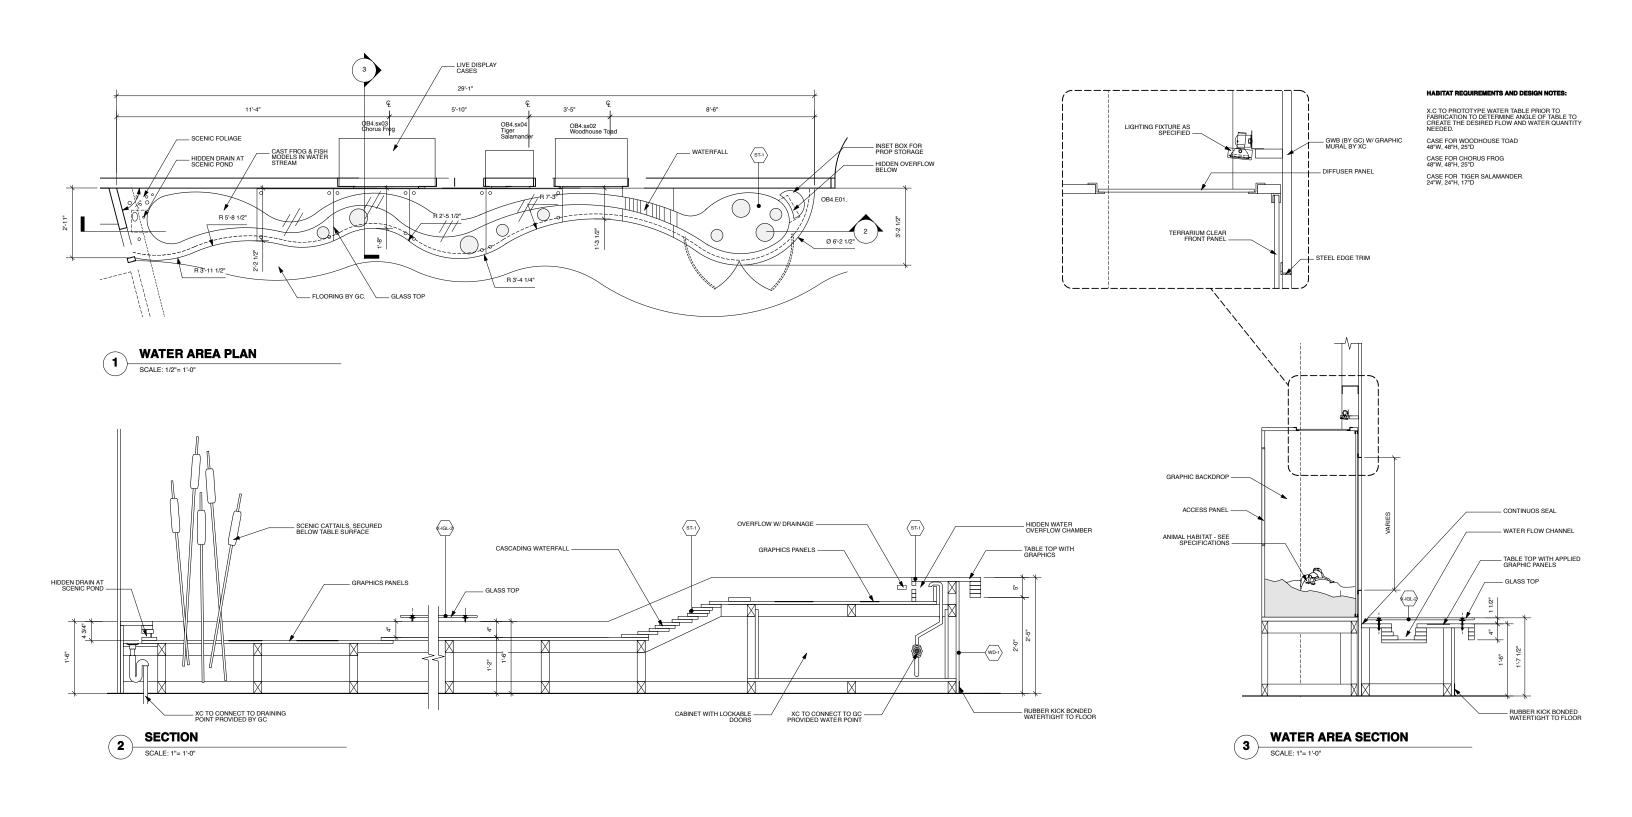

UNIVERSITY OF UTAH, SALT LAKE CITY, UTAH

Owner

UMNH
1390 East President's Circle
Salt Lake City, Utah 84112
801.581.6927 tel.

Polshek Partnership Archite 320 West 13th Street New York, New York 212.807.7171 tel. Architect of Record

cts LLP Gillies Stransky Brems
375 West 200 South
Salt Lake City, Utah
801 521 8801 44

Structural Engineer


Leslie E. Robertson Associates
30 Broad Street
New York, New York 10004
212.750.9000 tel.

Mechanical/Plumbing/FP Engineer Colvin Engineering Associates, Inc. 244 West 300 North Salt Lake City, Utah 84103 801.322.2400 tel Electrical/AV Engineer Spectrum Engineers 175 South Main Street Salt Lake City, Utah 84111 800.678.7077 tel Landscape Architect
Design Workshop, Inc.
1796 Prospector Avenue
Park City, Utah 84060
435.655.0915 tel.

Branston Partnershi 122 West 26th Stree New York, NY 1000 212.924.4050 tel.

BBI Engineering, Inc.
241 Quint Street
88 Pine Street
88 Pine Street
New York, New York 10005
212.334.8200 tel.

Exhibit Construction

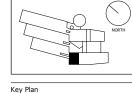


FD WS2rev Sept.22, 2008
FD WS2 Sept.9, 2008
100% DD June 2, 2008
XG 60% CD May 5, 2008
WS9 March. 26, 2008
WS8 Feb. 20, 2008
WS7 Dec. 18, 2007
50% DD Sept. 18, 2007
WS6 July 11, 2007
WS5 May 23, 2007
WS4 April 12, 2007

No. / Issue Name / Date


80% FD Dec.19, 2008 FD WS4 Nov.18, 2008 FD WS3 Oct.16, 2008 No. / Issue Name / Date Sheet Title
Level 2 Details: Water table
Our Backyard / Children's Gallery

Date
Project No.
Dec. 19, 2008

Dec. 19, 2008 0275
Scale* Sheet No.
As Noted X2-BY-3.00

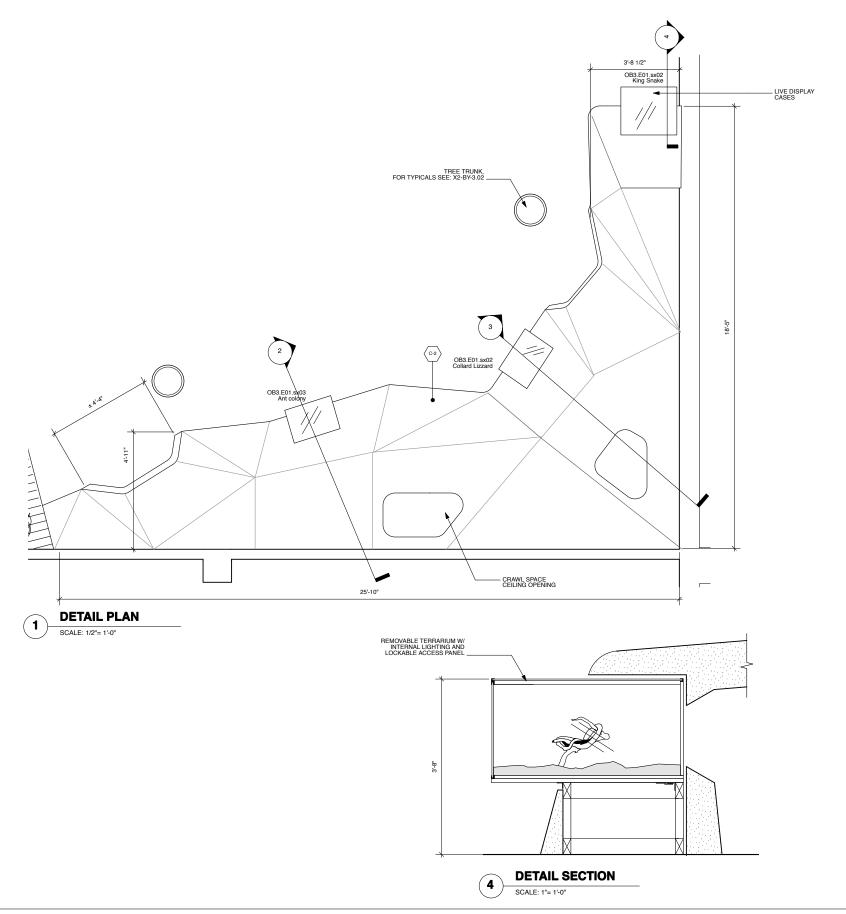

CASE FOR COLLARD LIZZARD 24"W, 24"D, 18"D CASE FOR ANT COLONY 24"W, 24"D, 18"D INTERNAL STRUCTURE _ REMOVABLE TERRARIUM WA INTERNAL LIGHTING AND LOCKABLE ACCESS PANEL CRAWL SPACE TACTILE ANIMAL MODEL **DETAIL SECTION**

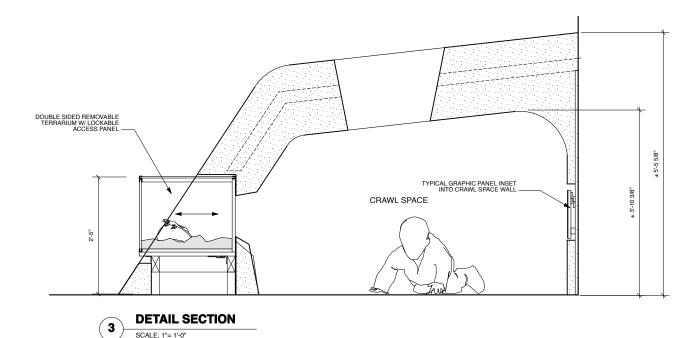

UTAH MUSEUM OF NATURAL HISTORY

UNIVERSITY OF UTAH, SALT LAKE CITY, UTAH

Owner
UMNH 1390 East President's Circle Salt Lake City, Utah 84112 801.581.6927 tel.

Structural Engineer Leslie E. Robertson Associates 30 Broad Street New York, New York 10004 212.750.9000 tel.


Colvin Engineering Associates, Inc. 244 West 300 North Salt Lake City, Utah 84103 801.322.2400 tel

Electrical/AV Engineer

Landscape Architect

BBI Engineering, Inc. 241 Quint Street San Francisco, CA 94124 415 685 9555 tel.

Exhibit Construction Ralph Appelbaum Associates 88 Pine Street New York, New York 10005 212.334.8200 tel.

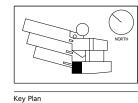

SCALE: 1"= 1'-0"

FD WS2rev	Sept.22, 2008
FD WS2	Sept.9, 2008
100% DD	June 2, 2008
XG 60% CD	
WS9	March. 26, 2008
WS8	Feb. 20, 2008
WS7	Dec. 18, 2007
50% DD	Sept. 18, 2007
WS6	July 11, 2007
WS5	May 23, 2007
WS4	April 12, 2007
No. / Issue Nan	ne / Date


80% FD Dec.19, 2008 FD WS4 Nov.18, 2008 FD WS3 Oct.16, 2008 No. / Issue Name / Date

Sheet Title
Level 2 Details: Underground Crawl
Our Backyard / Children's Gallery Date

Dec. 19, 2008 Sheet No.

HABITAT REQUIREMENTS AND DESIGN NOTES: PROVIDE HEAT STRIPS IN TANKS

X2-BY-3.01

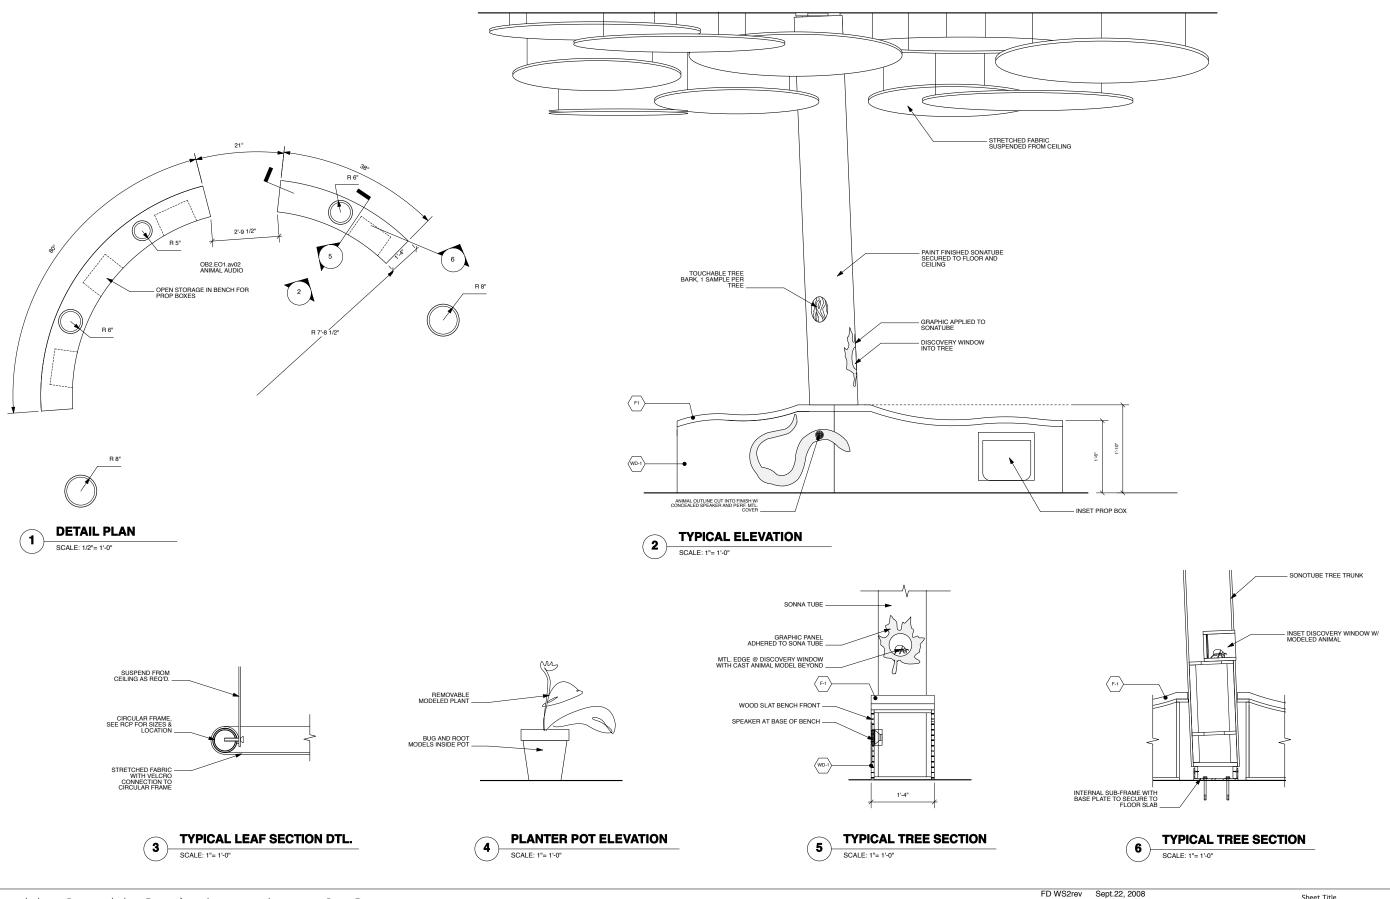

UNIVERSITY OF UTAH, SALT LAKE CITY, UTAH

Owner
UMNH 1390 East President's Circle Salt Lake City, Utah 84112 801.581.6927 tel.


Structural Engineer Leslie E. Robertson Associates 30 Broad Street New York, New York 10004 212.750.9000 tel.

Electrical/AV Engineer Spectrum Engineers 175 South Main Street Salt Lake City, Utah 84111 800.678.7077 tel

Landscape Architect

BBI Engineering, Inc. 241 Quint Street San Francisco, CA 94124 415 685 9555 tel.

Exhibit Construction Ralph Appelbaum Associates 88 Pine Street New York, New York 10005 212.334.8200 tel.

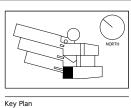


	FD WS2rev	Sept.22, 20
$\overline{}$	FD WS2	Sept.9, 200
71	100% DD	June 2, 2008
71	XG 60% CD	
n I	WS9	March. 26, 200
	WS8	Feb. 20, 2008
	WS7	Dec. 18, 200
	50% DD	Sept. 18, 200
	WS6	July 11, 2007
	WS5	May 23, 200
	WS4	April 12, 200

No. / Issue Name / Date


80% FD Dec.19, 2008 FD WS4 Nov.18, 2008 FD WS3 Oct.16, 2008 No. / Issue Name / Date

Sheet Title
Level 2 Details: Free Play Area Our Backyard / Children's Gallery Project No.

Dec. 19, 2008 Sheet No. X2-BY-3.02

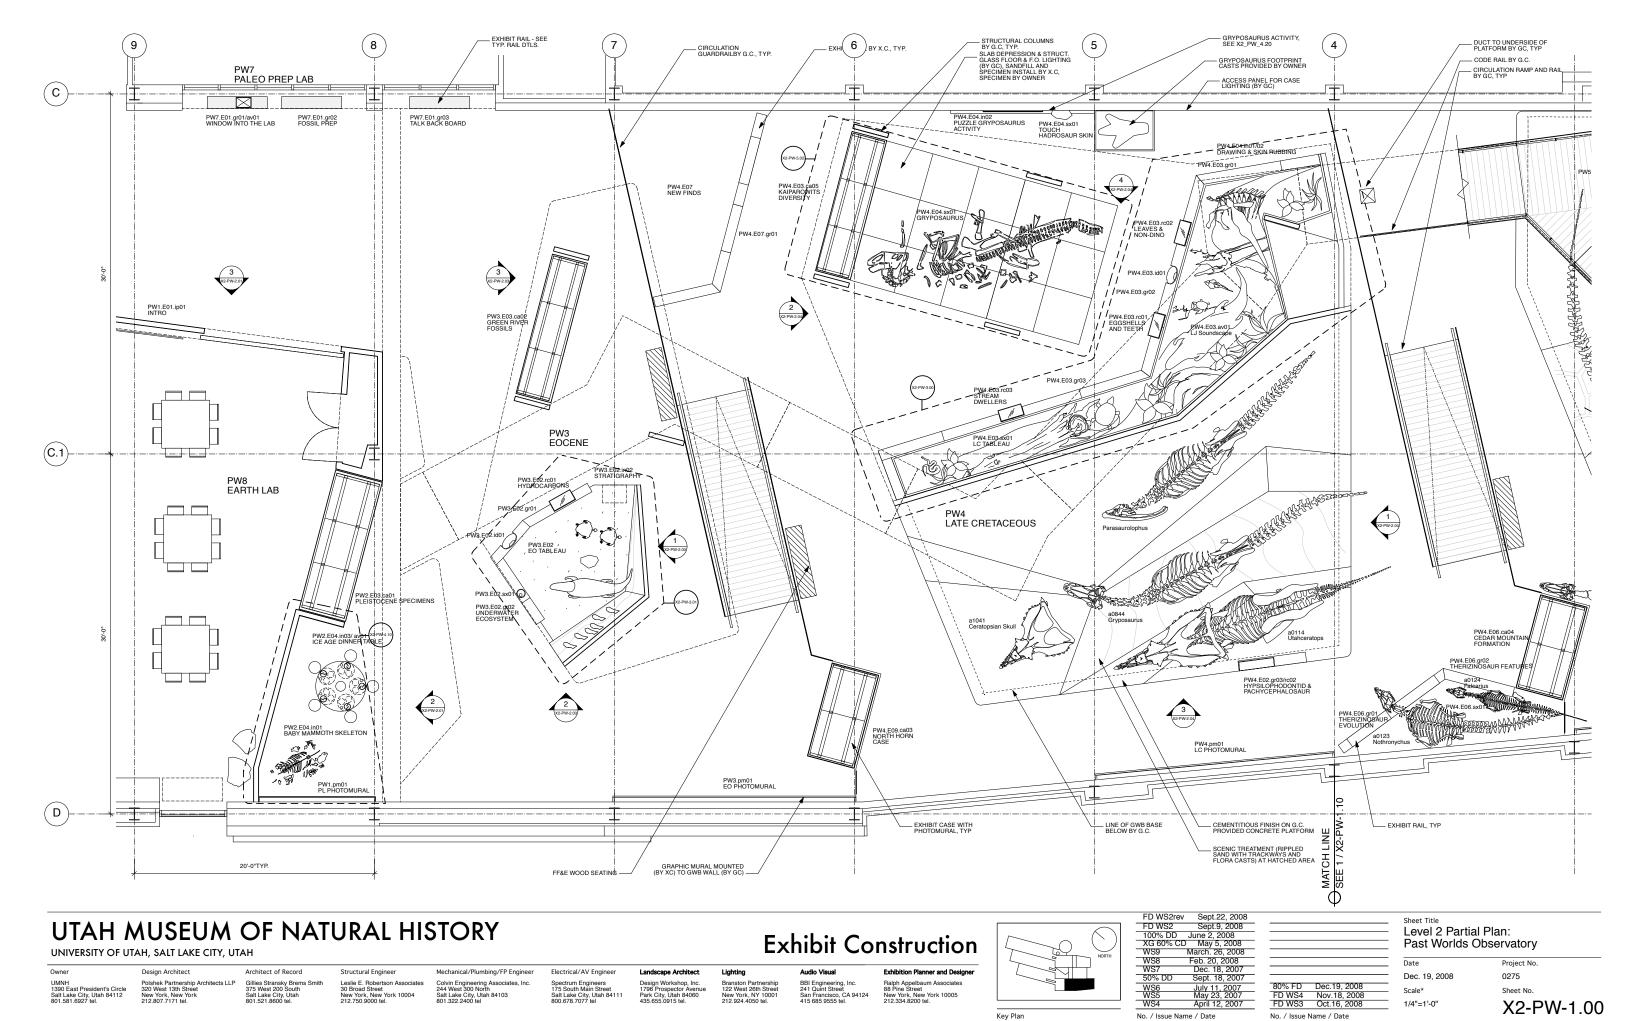

*Note: Scale Given for Full Size Drawing Sheet (22" x 34")

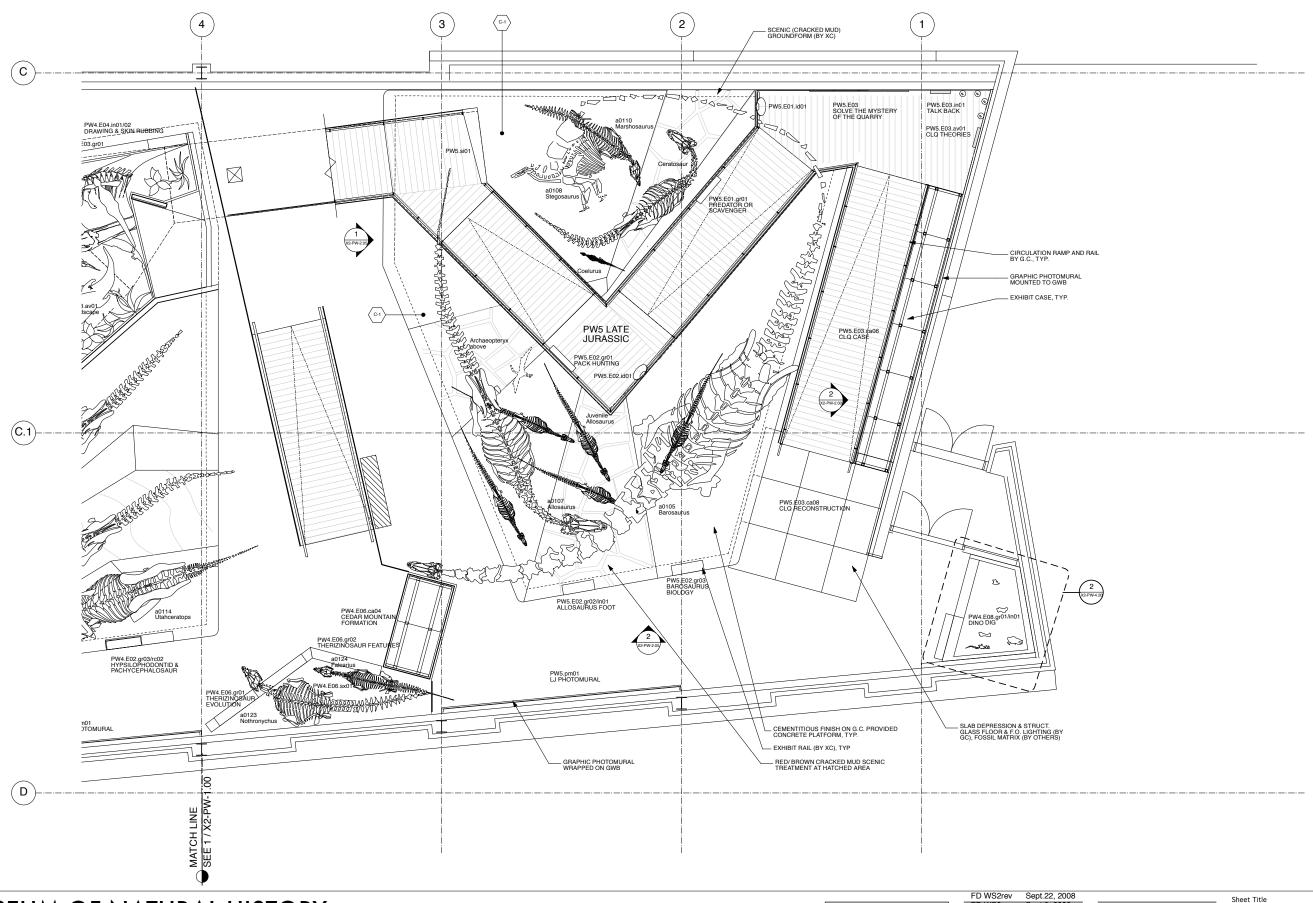

UNIVERSITY OF UTAH, SALT LAKE CITY, UTAH

Owner
UMNH
1390 East President's Circle
Salt Lake City, Utah 84112
801.581.6927 tel.

Polshek Partnership Archite 320 West 13th Street New York, New York Architect of Record

S LLP Gillies Stransky Brems
375 West 200 South
Salt Lake City, Utah

Record Structural Engineer
sky Brems Smith 0 South 30 Broad Street
y, Utah New York, New York 10004
0 tel. 212.750.9000 tel.

Mechanical/Plumbing/FP Engasociates
Colvin Engineering Associates
244 West 300 North
0004
Salt Lake City, Utah 84103

Electrical/AV Engineer Spectrum Engineers 175 South Main Street Salt Lake City, Utah 841 800.678.7077 tel

Landscape Architer
Design Workshop, In 1796 Prospector Ave Park City, Utah 8406 435.655.0915 tel.

cc. Branston Partne enue 122 West 26th S New York, NY 1 212.924.4050 te


nership BBI Eng 1 Street 241 Quii 7 10001 San Fran tel. 415 685

Audio Visual

BBI Engineering, Inc.
241 Quint Street
San Francisco, CA 94124
415 685 9555 tel.

Exhibition Planter am
Ralph Appelbaum Assc
88 Pine Street
New York, Ne


Exhibit Construction

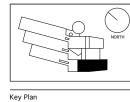

	FD WS2rev	Sept.22, 2008
1	FD WS2	Sept.9, 2008
	100% DD	June 2, 2008
	XG 60% CD	
	WS9	March. 26, 2008
	WS8	Feb. 20, 2008
	WS7	Dec. 18, 2007
	50% DD	Sept. 18, 2007
	WS6	July 11, 2007
	WS5	May 23, 2007
	WS4	April 12, 2007
	No. / Issue Nan	ne / Date

	Sheet Title Level 2 Partia Past Worlds 0	
	Date	Project No.
	Dec. 19, 2008	0275
0% FD Dec.19, 2008 D WS4 Nov.18, 2008	— Scale*	Sheet No.
D WS3 Oct.16, 2008	1/4"=1'-0"	X2-PW-1.10
/ Janua Nama / Data		71

No. / Issue Name / Date

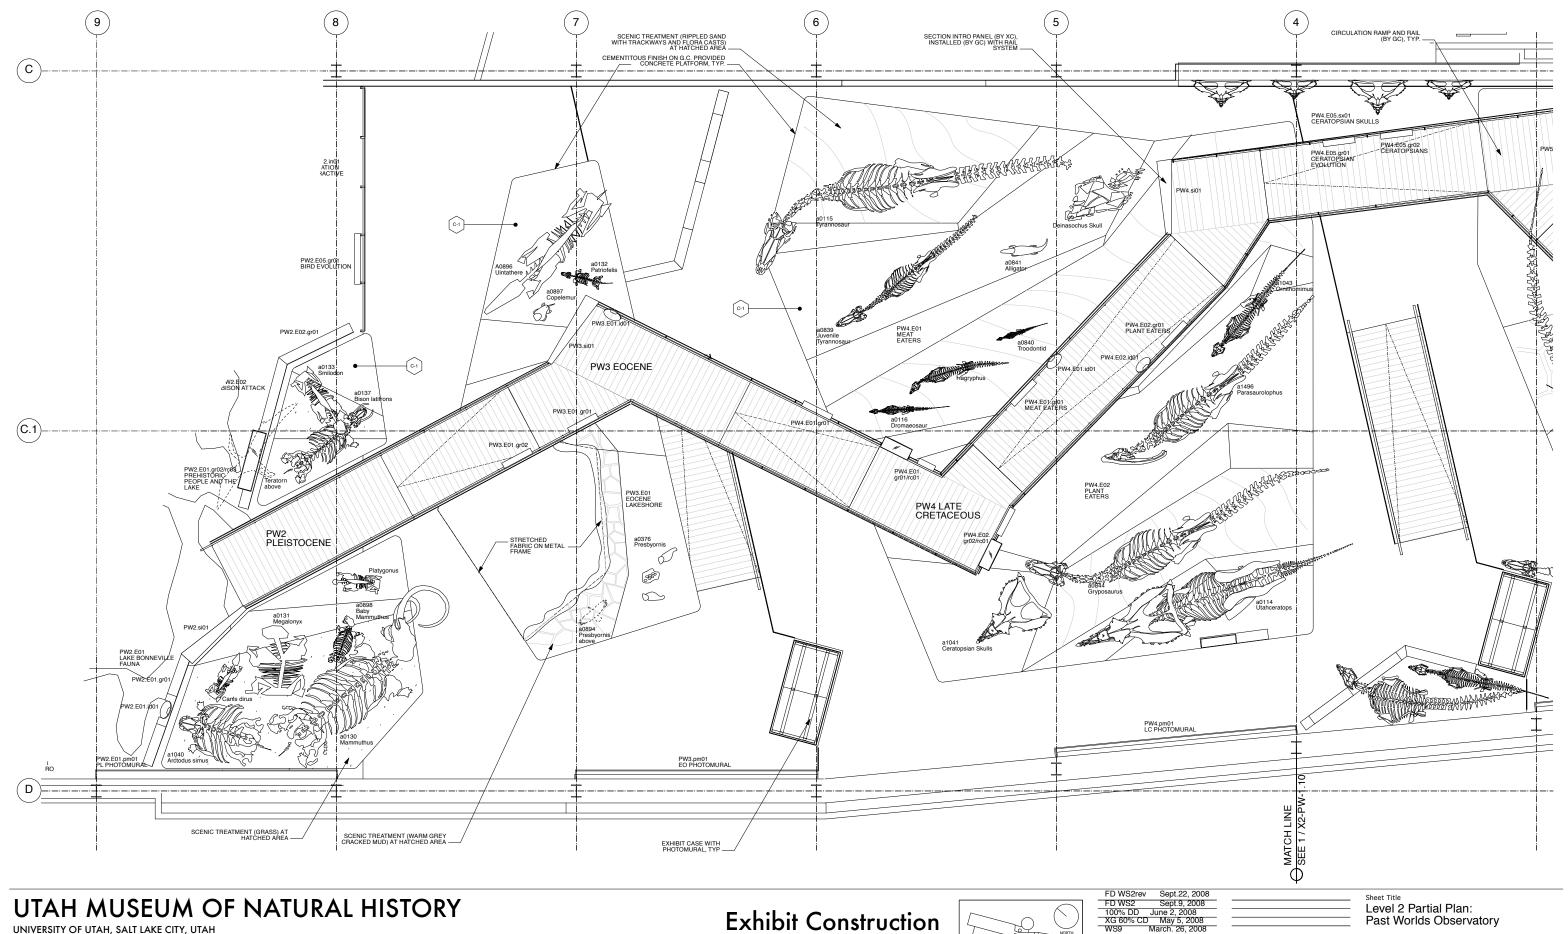

UNIVERSITY OF UTAH, SALT LAKE CITY, UTAH


BBI Engineering, Inc. 241 Quint Street San Francisco, CA 94124 415 685 9555 tel.

Key Plan

NORTH

FD WS2rev	Sept.22, 2008
FD WS2	Sept.9, 2008
100% DD	June 2, 2008
XG 60% CD	
WS9	March. 26, 2008
WS8	Feb. 20, 2008
WS7	Dec. 18, 2007
50% DD	Sept. 18, 2007
WS6	July 11, 2007
WS5	May 23, 2007
WS4	April 12, 2007

Sheet Title
Level 2 Partial Plan:
Past Worlds Observatory Dec. 19, 2008 80% FD Dec.19, 2008 FD WS4 Nov.18, 2008 FD WS3 Oct.16, 2008 X3-PW-1.00

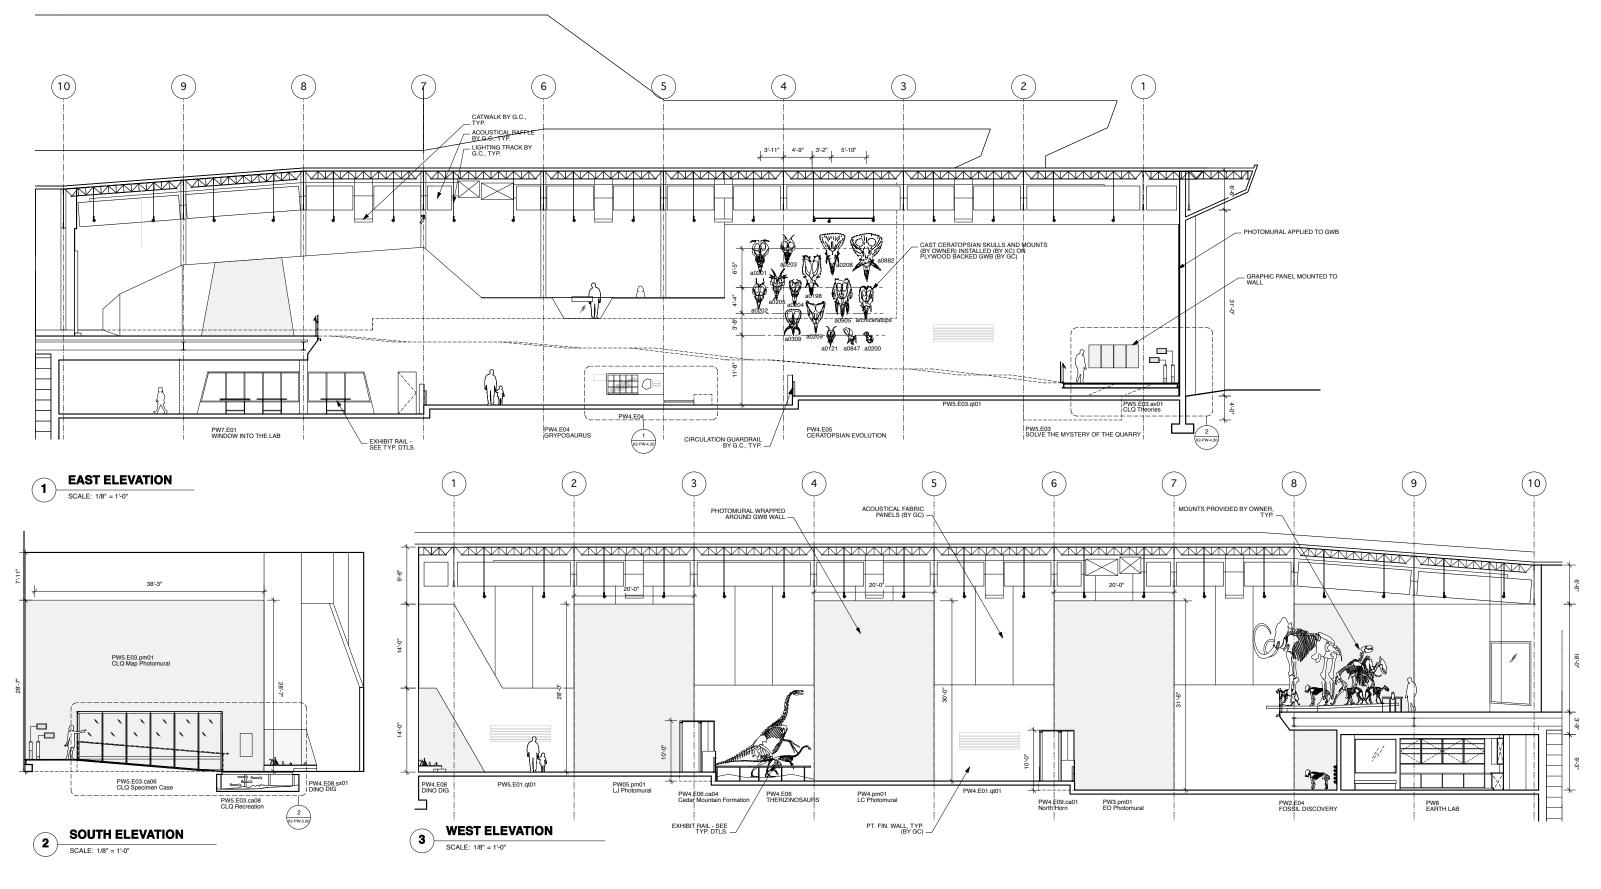

UNIVERSITY OF UTAH, SALT LAKE CITY, UTAH


Electrical/AV Engineer

BBI Engineering, Inc. 241 Quint Street San Francisco, CA 94124 415 685 9555 tel.




FD WS2rev	Sept.22, 2008
FD WS2	Sept.9, 2008
100% DD	June 2, 2008
XG 60% CI	
WS9	March. 26, 2008
WS8	Feb. 20, 2008
WS7	Dec. 18, 2007
50% DD	Sept. 18, 2007
WS6	July 11, 2007
WS5	May 23, 2007
WS4	April 12, 2007

Sections & Elevations: Past Worlds Observatory 80% FD Dec.19, 2008 FD WS4 Nov.18, 2008 FD WS3 Oct.16, 2008 X2-PW-2.00

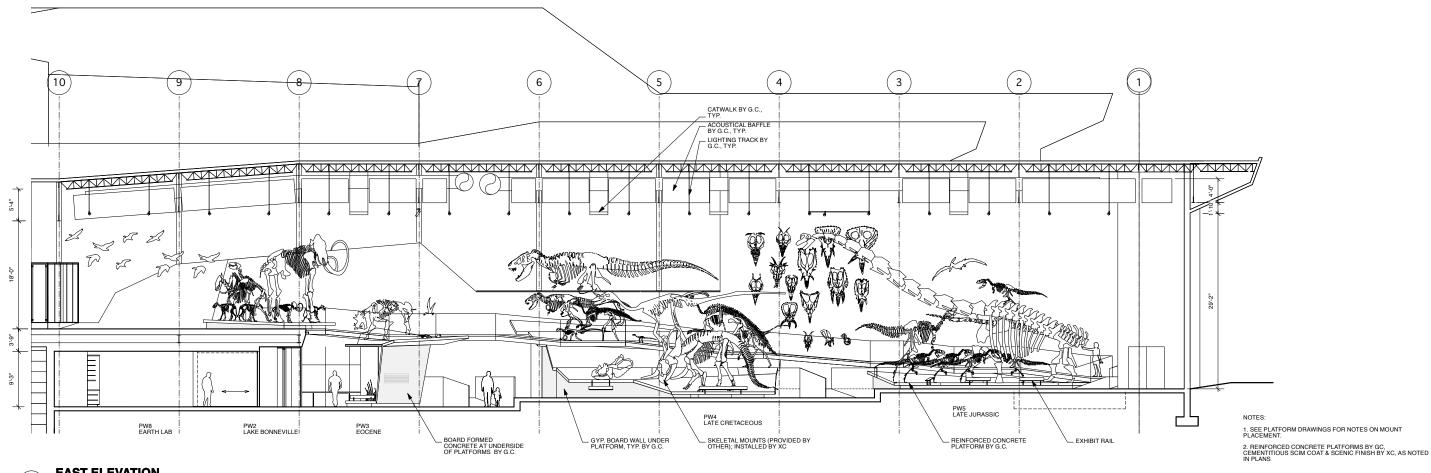



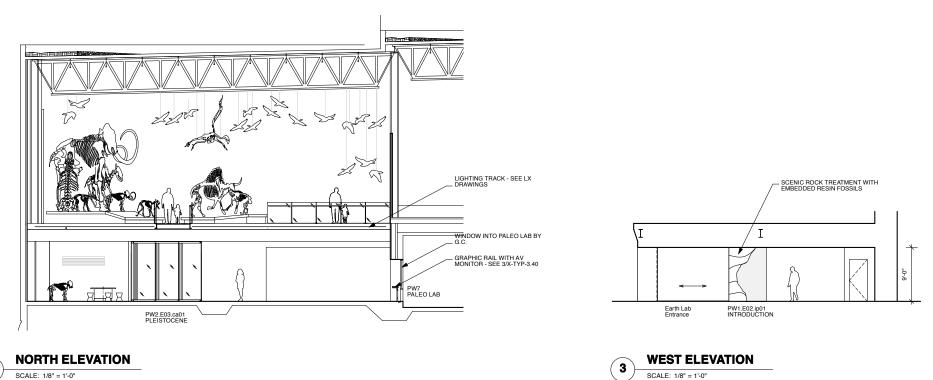

UNIVERSITY OF UTAH, SALT LAKE CITY, UTAH


Structural Engineer Leslie E. Robertson Associate 30 Broad Street New York, New York 10004 212.750.9000 tel.

Electrical/AV Engineer

BBI Engineering, Inc. 241 Quint Street San Francisco, CA 94124 415 685 9555 tel.

Exhibit Construction

Ralph Appelbaum Associates 88 Pine Street New York, New York 10005 212.334.8200 tel.

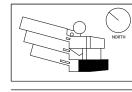

Key Plan

FD WS2rev Sept.22, 2008 FD W5210.
FD W52 Sept.9, 2000
100% DD June 2, 2008
74 80% CD May 5, 2008 Sept.9, 2008


No. / Issue Name / Date


FD WS4 Nov.18, 2008 FD WS3 Oct.16, 2008 No. / Issue Name / Date

Sections & Elevations: Past Worlds Observatory

0275 Dec. 19, 2008 Sheet No.


X2-PW-2.01

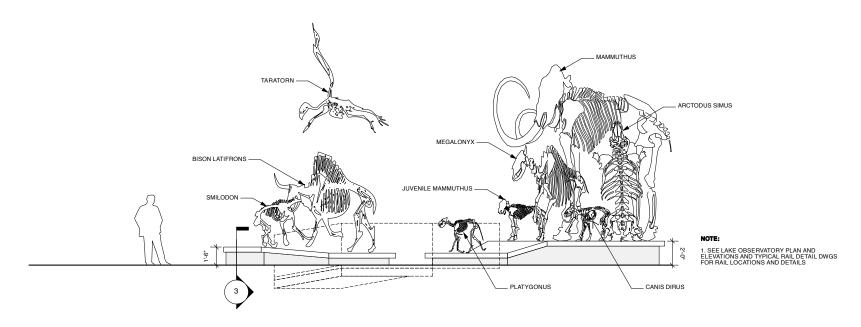

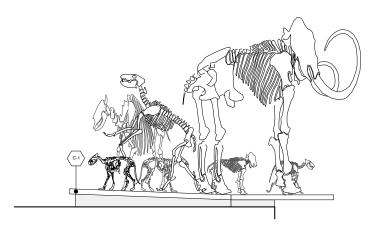

NORTH ELEVATION PLEISTOCENE PLATFORM


SCALE: 1/4"= 1'-0"

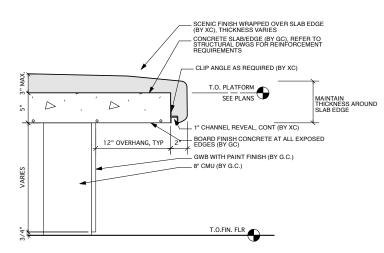

SECTION DETAIL: SLAB OVERHANG SCALE: 1 1/2"= 1'-0"

EAST ELEVATION PLEISTOCENE PLATFORM

SCALE: 1/4"= 1'-0"

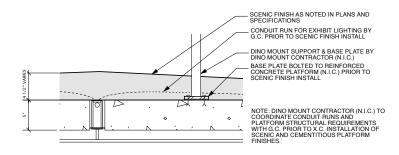

SECTION DETAIL: DINO MOUNT CONNECTION SCALE: 1 1/2"= 1'-0"

UTAH MUSEUM OF NATURAL HISTORY

UNIVERSITY OF UTAH, SALT LAKE CITY, UTAH

()wner
	JMNH 390 East President's Circle Salt Lake City, Utah 84112 801.581.6927 tel.


Structural Engineer Leslie E. Robertson Associate 30 Broad Street New York, New York 10004 212.750.9000 tel. Mechanical/Plumbing/FP Engineer

Electrical/AV Engineer

Landscape Architect

BBI Engineering, Inc. 241 Quint Street San Francisco, CA 94124 415 685 9555 tel. Ralph Appelbaum Associates 88 Pine Street New York, New York 10005 212.334.8200 tel.

Exhibit Construction

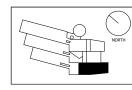

Key Plan


	FD WS2rev	Sept.22, 2008
	FD WS2	Sept.9, 2008
71	100% DD	June 2, 2008
Л	XG 60% CD	
		March. 26, 2008
	WS8	Feb. 20, 2008
	WS7	Dec. 18, 2007
	50% DD	Sept. 18, 2007
	WS6	July 11, 2007 May 23, 2007
	WS5	
	WS4	April 12, 2007

No. / Issue Name / Date


3			
_			
_			
_			
_			
_		B (0.000	
	80% FD	Dec.19, 2008	
	FD WS4	Nov.18, 2008	
_	FD WS3	Oct.16, 2008	

No. / Issue Name / Date


Sheet Title
Elevations: Past Worlds
Observatory Platform PL Date Project No. 0275 Dec. 19, 2008 Scale* Sheet No. X2-PW-2.02

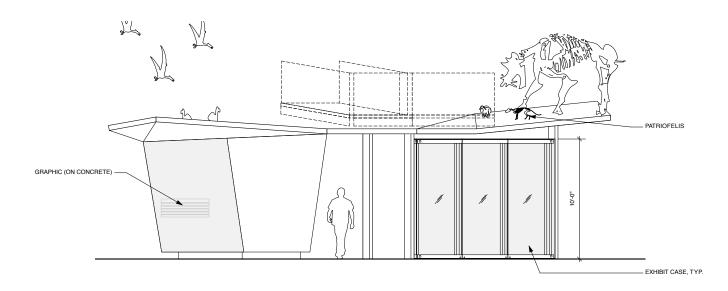




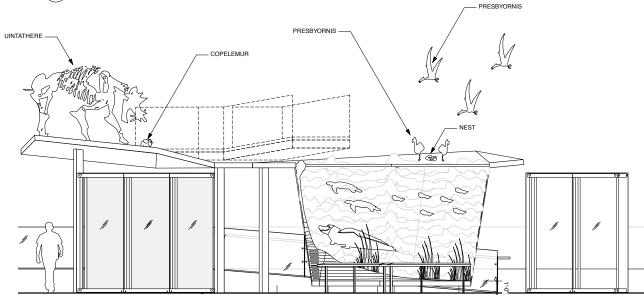

NORTH ELEVATION EOCENE PLATFORM SCALE: 1/4"= 1'-0"

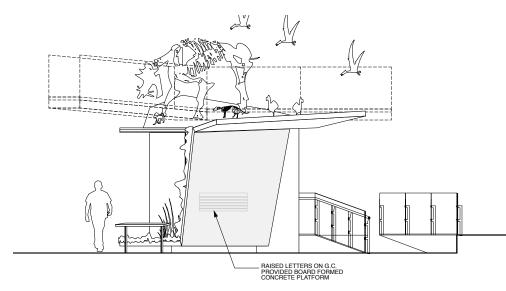

WEST ELEVATION EOCENE PLATFORM

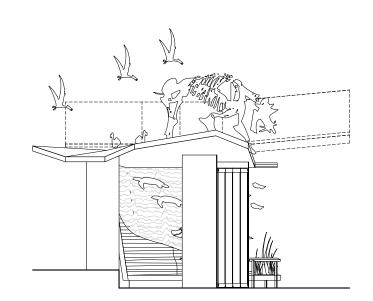

EAST ELEVATION EOCENE PLATFORM

SCALE: 1/4"= 1'-0"

UTAH MUSEUM OF NATURAL HISTORY

UNIVERSITY OF UTAH, SALT LAKE CITY, UTAH

Owner	
UMNH 1390 East Presider Salt Lake City, Uta 801.581.6927 tel.	

BBI Engineering, Inc. 241 Quint Street San Francisco, CA 94124 415 685 9555 tel.




	FD WS2rev	Sept.
	FD WS2	Sept.
\wedge		June 2,
\cap \setminus \bot	XG 60% CD	
NORTH		March. 2
i ¬ ''''''	WS8	Feb. 20
	WS7	Dec. 1
	50% DD	Sept. 1
	WS6	July 1
	WS5	May 2
	WS4	April 1


$\overline{}$	FD WS2	Sept.9, 2008
М	100% DD	June 2, 2008
Л		May 5, 2008
í	WS9	March. 26, 2008
.	WS8	Feb. 20, 2008
	WS7	Dec. 18, 2007
	50% DD	Sept. 18, 2007
	WS6	July 11, 2007
	WS5	May 23, 2007
	WS4	April 12, 2007

No. / Issue Name / Date

Sheet Title
Elevations: Past Worlds
Observatory Platform - EO FD WS4 Nov.18, 2008 FD WS3 Oct.16, 2008

X2-PW-2.03

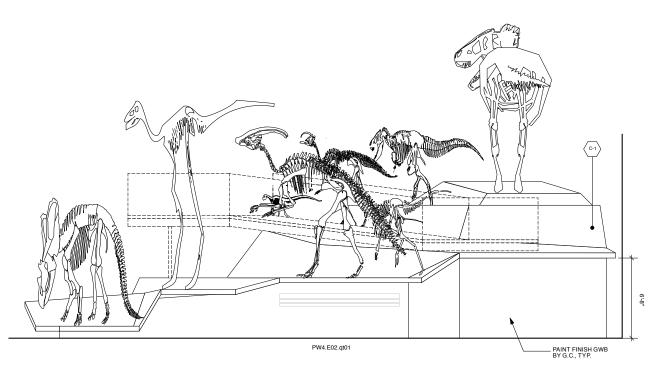


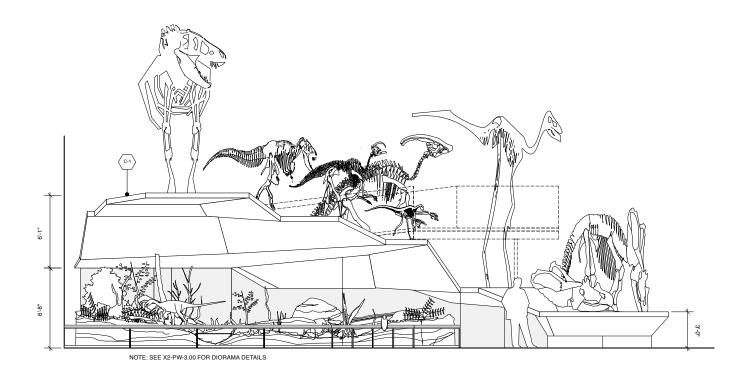

SOUTH ELEVATION LATE CRETACEOUS PLATFORM SCALE: 1/4"= 1'-0"

___ UTAHCERATOPS PARASAUROLOPHUS

NORTH ELEVATION LATE CRETACEOUS PLATFORM SCALE: 1/4"= 1'-0"

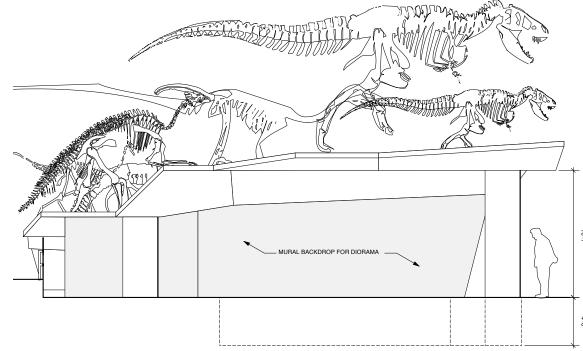


UTAH MUSEUM OF NATURAL HISTORY

WEST ELEVATION LATE CRETACEOUS PLATFORM

UNIVERSITY OF UTAH, SALT LAKE CITY, UTAH

Owner
UMNH 1390 East President's Circle Salt Lake City, Utah 84112 801.581.6927 tel.

Exhibit Construction

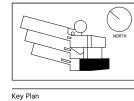



	FD WS2rev	Sept.22,
$\overline{}$	FD WS2	Sept.9, 2
. 11	100% DD	June 2, 200
71	XG 60% CD	
RTH		March. 26, 2
	WS8	Feb. 20, 20
	WS7	Dec. 18, 2
	50% DD	Sept. 18, 2
	WS6	July 11, 2
	WS5	July 11, 2 May 23, 2
	WS4	April 12, 2
	`	

EAST ELEVATION LATE CRETACEOUS PLATFORM

D WS2rev	Sept.22, 2008	
D WS2	Sept.9, 2008	_
	June 2, 2008	
(G 60% CD		
	March. 26, 2008	
VS8	Feb. 20, 2008	
VS7	Dec. 18, 2007	_
0% DD	Sept. 18, 2007	_
VS6	July 11, 2007	- 2
VS5	May 23, 2007	F
VS4	April 12, 2007	T

		E	eet Title levations: Pa bservatory F	ast Worlds Platform -LC
		Da	te	Project No.
		De	ec. 19, 2008	0275
80% FD FD WS4	Dec.19, 2008 Nov 18, 2008	Sca	ale*	Sheet No.

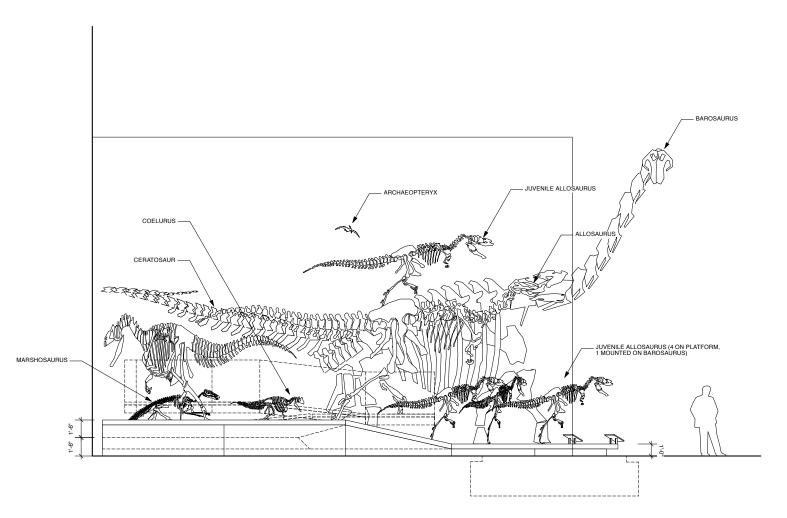

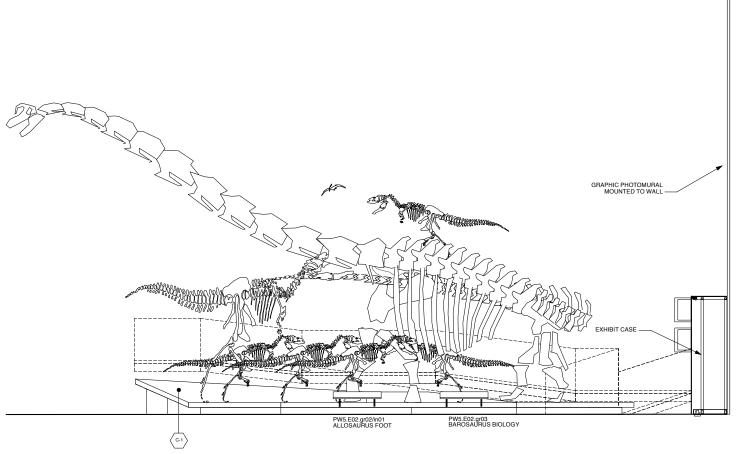

SOUTH ELEVATION LATE JURASSIC PLATFORM SCALE: 1/4"= 1'-0"

EAST ELEVATION LATE JURASSIC PLATFORM SCALE: 1/4"= 1'-0"

UTAH MUSEUM OF NATURAL HISTORY


UNIVERSITY OF UTAH, SALT LAKE CITY, UTAH



|--|

	FD WS2rev	Sept.22, 20
$\overline{}$	FD WS2	Sept.9, 200
71	100% DD	June 2, 2008
Л	XG 60% CD	
TH	WS9	March. 26, 200
	WS8	Feb. 20, 2008
	WS7	Dec. 18, 200
	50% DD	Sept. 18, 200
	WS6	July 11, 2007 May 23, 200
	WS5	May 23, 200
	WS4	April 12, 200

Sheet Title Elevations: Pa Observatory F	
Date	Project No.
Dec. 19, 2008	0275
Scale*	Sheet No.
1/4"=1'-0"	X2-PW
	Elevations: Pa Observatory F Date Dec. 19, 2008 Scale*

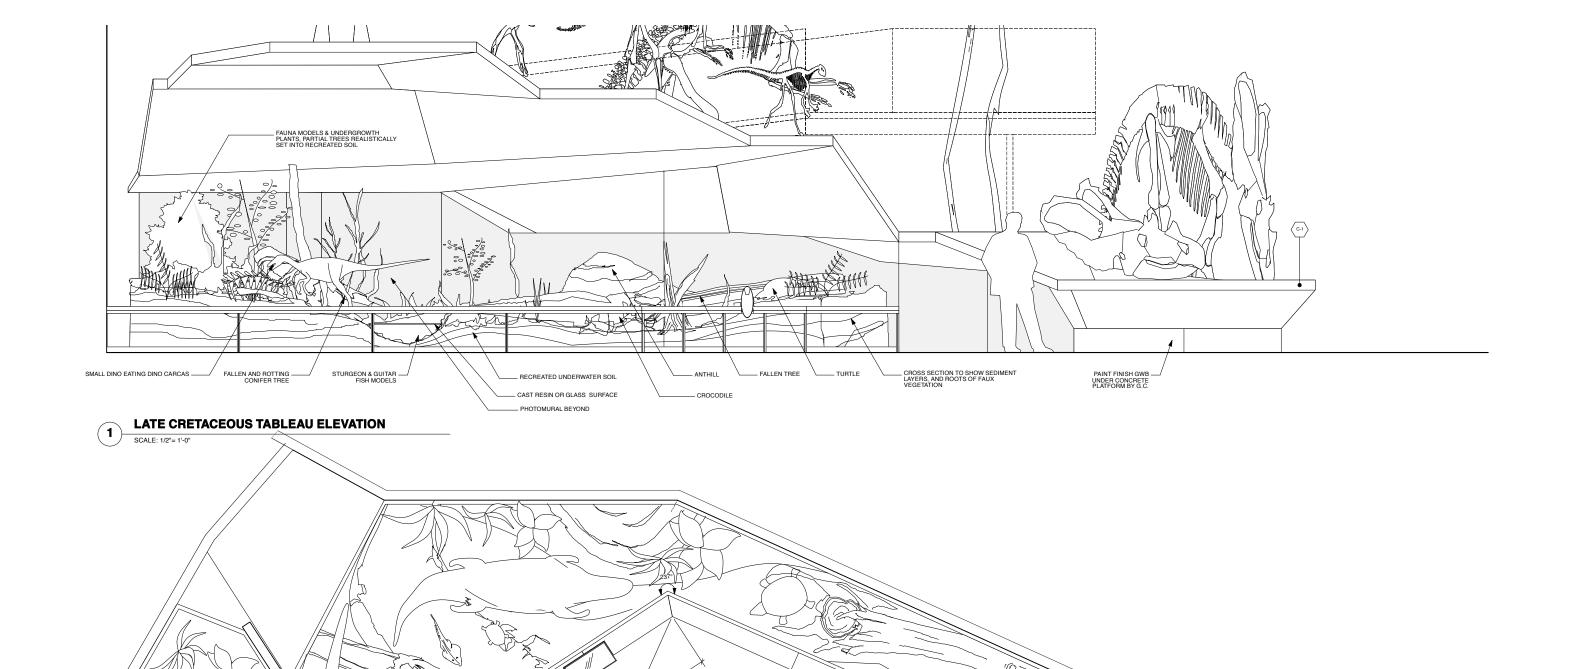

DESCRIPTION OF WORK:
 LOWER CRETACEOUS: VISITORS SEE A DIORAMA REPRESENTING A
 SWAMPY BAYOU OF THE LOWER CRETACEOUS ERA COMPRISED
 PARTIALLY OF A RUNNING WATER FEATURE, AND SO DENSE WITH
 PLANT'S THAT VISITORS CAN NOT SEE THE SKY.

2. XC TO PROVIDE SAMPLES OF ALL SURFACES PRIOR TO FABRICATION FOR RAA TO APPROVE.
3. SEE DIORAMA SPECIFICATIONS FOR NOTES ON FINISHES AND TREATMENTS.
4. DELICATE MODELS TO BE BEYOND ARMS REACH

UTAH MUSEUM OF NATURAL HISTORY

LATE CRETACEOUS TABLEAU PLAN

PW4.E03.gr01

UNIVERSITY OF UTAH, SALT LAKE CITY, UTAH

Leslie E. Robertson Associates 30 Broad Street New York, New York 10004 212.750.9000 tel.

PW4.E03.gr02

BBI Engineering, Inc. 241 Quint Street San Francisco, CA 94124 415 685 9555 tel.



Key Plan

PW4.E03.rc03 STREAM DWELLERS

PW4.E03.gr03


FD WS2rev	Sept.22, 2008
FD WS2	Sept.9, 2008
100% DD	June 2, 2008
XG 60% CD	
WS9	March. 26, 2008
WS8	Feb. 20, 2008
WS7	Dec. 18, 2007
50% DD	Sept. 18, 2007
WS6	July 11, 2007
WS5	May 23, 2007
WS4	April 12, 2007

No. / Issue Name / Date


80% FD	
80% FD FD WS4	Dec.19, 2008 Nov.18, 2008

Sheet Title
Details: Past Worlds Late Cretaceous Diorama


Date 0275 Dec. 19, 2008 Scale* X2-PW-3.00

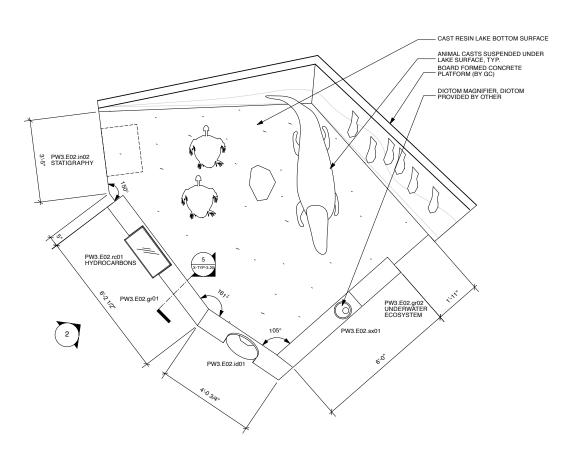

PLAN: EOCENE TABLEAU

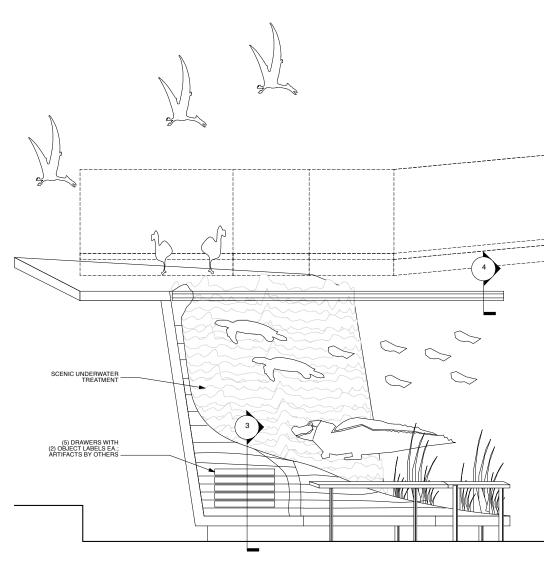


ELEVATION: EOCENE TABLEAU

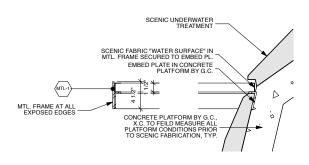

SECTION DETAIL: "WATER SURFACE"

SCALE: 1/2"= 1'-0"

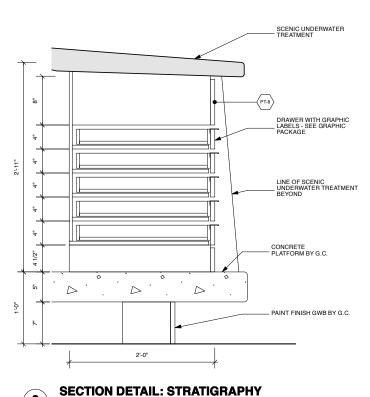

3

1. DESCRIPTION OF WORK: VISITORS SEE A DIORAMA REPRESENTING THE FOSSIL LAKE AND ITS SHORELINE.

THE FOSSIL LAKE AND ITS SHORELINE.

ELEMENTS INCLUDE: STROMATOLITES CREATING AN UNDULATING VERTICAL WALL FROM THE FLAT BOTTOM OF LAKE TO SURFACE, STICKING OUT OF WATER SURFACE BY 6-12 INCHES, WHITE OOLITIC SAND IN BOTTOM OF LAKE, INSECT LARYAGE IN WATER, 2 PRESBYDRIS FOSSIL MOUNTS W. MEST W. 8 EGGS AND TRACKS, CROCODIE W. SURFACE, CROCODIE CHANGES CHOOL OF FISH, HARD-SHELLED TURTLE (BAPTYMES), SOFTSHELL TURTLE BOWFIN, CRAYFISH, 2 GARS ON BOTTOM OF LAKE BABRYOUNG CAUMAN MOSQUITOES.

DAMSELFLIES, CADDISFLIES W. EGGS ON STROMATOLITES, SCOPPION FLIES, MARCHELIES, MOSQUITOES, SVAMORE, POPLAR WILLOW AND BIRCH TREE LEAVES, AND OTHER CHARACTERISTIC PLANTS AND ANIMALS/JOBOTHERS PROCEIS ASSOCIATED WITH THE ECCENE LAKESHORE COMMUNITY.

2.XC TO PROVIDE SAMPLES OF ALL SURFACES PRIOR TO FABRICATION FOR RAA TO APPROVE.
3. SEE DIORAMA SPECIFICATIONS FOR NOTES ON FINISHES AND TREATMENTS.
4. DELICATE MODELS TO BE BEYOND ARMS REACH

UTAH MUSEUM OF NATURAL HISTORY

UNIVERSITY OF UTAH, SALT LAKE CITY, UTAH

Owner	
UMNH 1390 East Pres Salt Lake City, 801.581.6927 to	Utah 84112

Architect of Record

Mechanical/Plumbing/FP Engineer Structural Engineer Leslie E. Robertson Associates 30 Broad Street New York, New York 10004 212.750.9000 tel. Colvin Engineering Associates, Inc. 244 West 300 North Salt Lake City, Utah 84103 801.322.2400 tel

Electrical/AV Engineer Spectrum Engineers 175 South Main Street Salt Lake City, Utah 84111 800.678.7077 tel

Landscape Architect

Lighting

BBI Engineering, Inc. 241 Quint Street San Francisco, CA 94124 415 685 9555 tel.

Exhibit Construction Ralph Appelbaum Associates 88 Pine Street New York, New York 10005 212.334.8200 tel.

			NORT
Key Pla	n		

	FD WS2rev	Sept.22, 2008
abla	FD WS2	Sept.9, 2008
71		June 2, 2008
Л	XG 60% CD	
í		March. 26, 2008
	WS8	Feb. 20, 2008
	WS7	Dec. 18, 2007
	50% DD	Sept. 18, 2007
	WS6	July 11, 2007
	WS5	May 23, 2007
	WS4	April 12, 2007


No. / Issue Name / Date


80% FD Dec.19, 2008 FD WS4 Nov.18, 2008 FD WS3 Oct.16, 2008 No. / Issue Name / Date

Details: Past Worlds Eocene Diorama

Date Project No. 0275 Dec. 19, 2008 Scale*

Sheet No. X2-PW-3.10

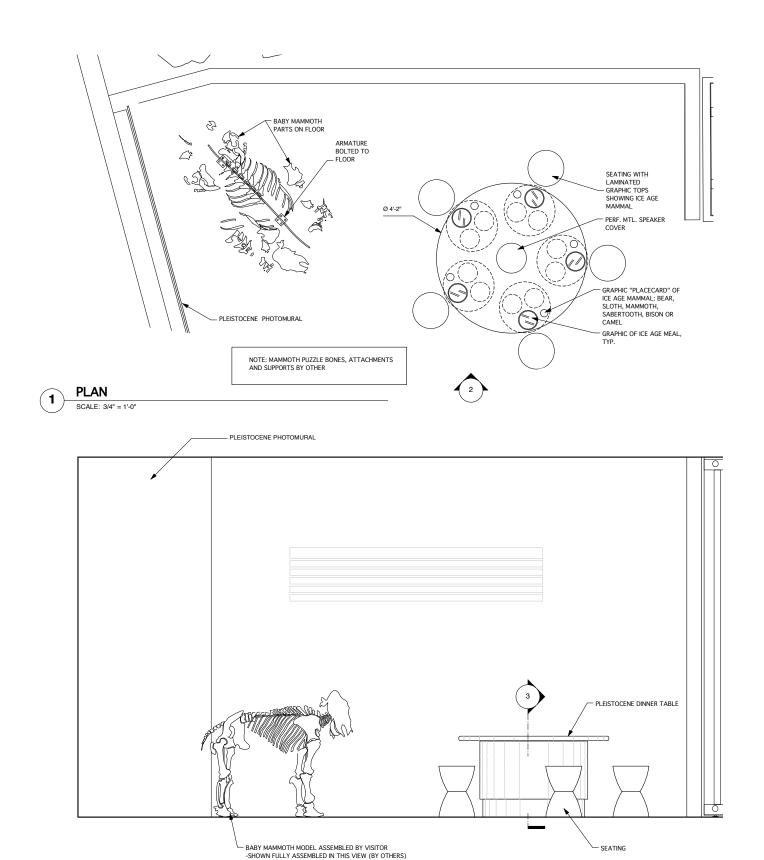

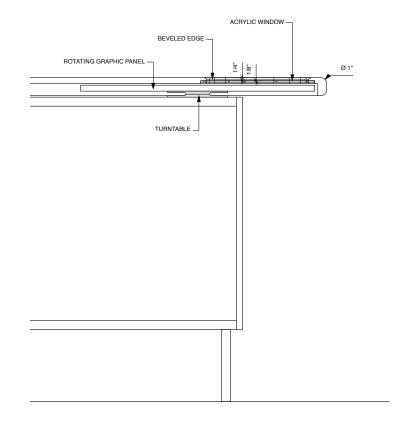

SECTION: PLEISTOCENE DINNER TABLE SCALE: 3" = 1'-0"

UTAH MUSEUM OF NATURAL HISTORY

UNIVERSITY OF UTAH, SALT LAKE CITY, UTAH

Design Architect

ELEVATION

SCALE: 3/4" = 1'-0"

Structural Engineer Leslie E. Robertson Associates 30 Broad Street New York, New York 10004 212.750.9000 tel.

Mechanical/Plumbing/FP Engineer

Electrical/AV Engineer


BBI Engineering, Inc. 241 Quint Street San Francisco, CA 94124 415 685 9555 tel. Ralph Appelbaum Associates 88 Pine Street New York, New York 10005 212.334.8200 tel.



	FD WS2rev	Sept.22, 2008
	FD WS2	Sept.9, 2008
) I - '	100% DD	June 2, 2008
/ '	XG 60% CD	
	WS9	March. 26, 2008
	WS8	Feb. 20, 2008
	WS7	Dec. 18, 2007
	50% DD	Sept. 18, 2007
	WS6	July 11, 2007
	WS5	May 23, 2007
	WS4	April 12, 2007


No. / Issue Name / Date


	Sheet Title Level 2 Details: Baby Mammoth	+ Ice Age Dinner Table
	Date	Project No.
	Dec. 19, 2008	0275
80% FD Dec.19, 2008 FD WS4 Nov.18, 2008	Scale*	Sheet No.
FD WS3 Oct.16, 2008 No. / Issue Name / Date	varies	X2-PW-4.10

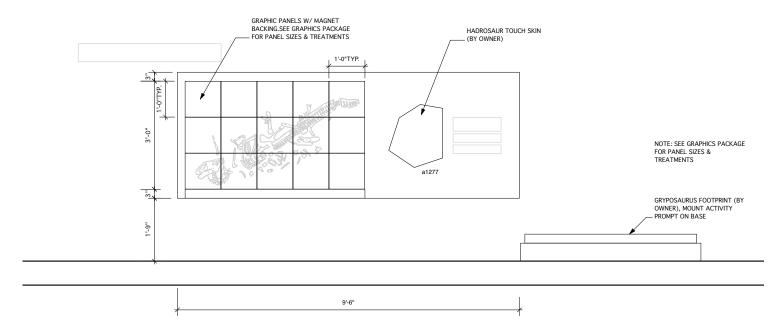

ELEVATION: GRYPOSAURUS ACTIVITIES

SCALE: 3/4" = 1'-0"

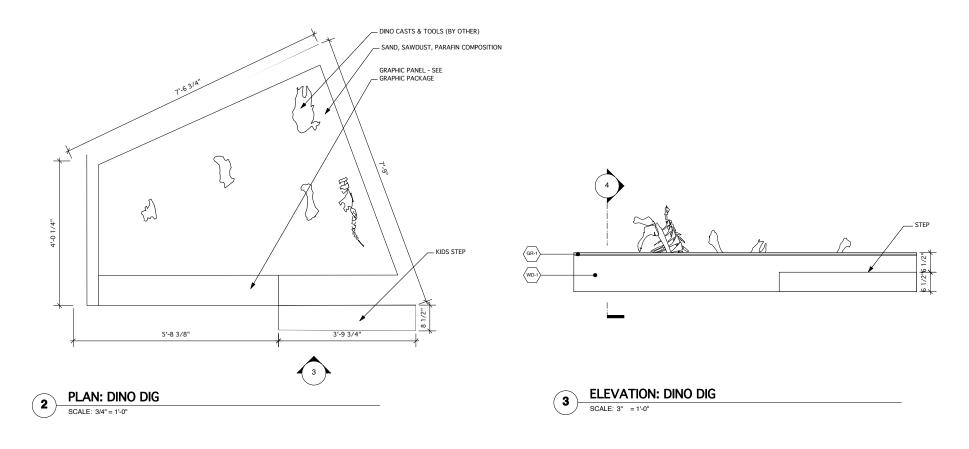

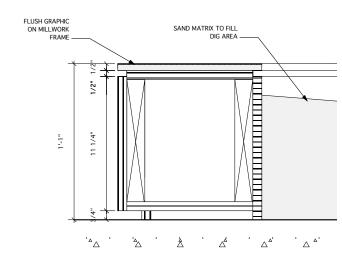

SECTION DETAIL: DINO DIG SCALE: 3/4" = 1'-0"

UTAH MUSEUM OF NATURAL HISTORY

UNIVERSITY OF UTAH, SALT LAKE CITY, UTAH

Owner
UMNH 1390 East President's Circle Salt Lake City, Utah 84112 801 581 6927 tel

Design Architect

Architect of Record Structural Engineer Leslie E. Robertson Associates 30 Broad Street New York, New York 10004 212.750.9000 tel.

Mechanical/Plumbing/FP Engineer Colvin Engineering Associates, Inc. 244 West 300 North Salt Lake City, Utah 84103 801.322.2400 tel

Electrical/AV Engineer

BBI Engineering, Inc. 241 Quint Street San Francisco, CA 94124 415 685 9555 tel.

Ralph Appelbaum Associates 88 Pine Street New York, New York 10005 212.334.8200 tel.


Exhibit Construction Key Plan

	FD WS2rev	Sept
	FD WS2	Sept.
\wedge	100% DD	June 2,
	XG 60% CD	
NORTH		March.
	WS8	Feb. 20
ブー	WS7	Dec. 1
	50% DD	Sept.
	WS6	July 1
	WS5	May 2
,	WS4	April 1


No. / Issue Name / Date


2008			
2008			
)8			
800			
2008			
800			
2007			
2007			
007	80% FD	Dec.19, 2008	
007	FD WS4	Nov.18, 2008	
2007	FD WS3	Oct.16, 2008	
	No / Issue N	lame / Date	

Level 2 Details: Past Worlds Gryphosaurus Activity and Dino Dig Project No. Dec. 19, 2008 0275 Sheet No. X2-PW-4.20

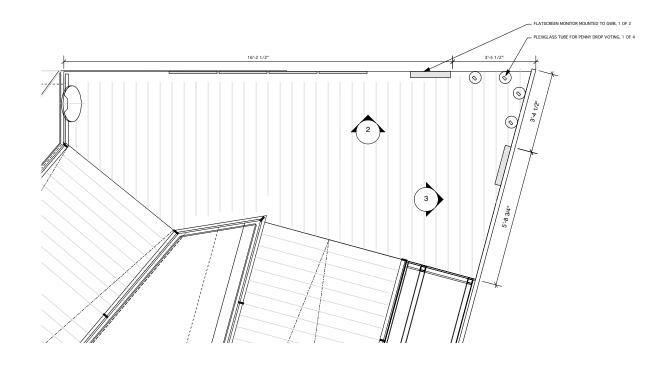

PLAN: CLEVLAND LYOD QUARRY
SCALE: 1/2" = 1'-0"

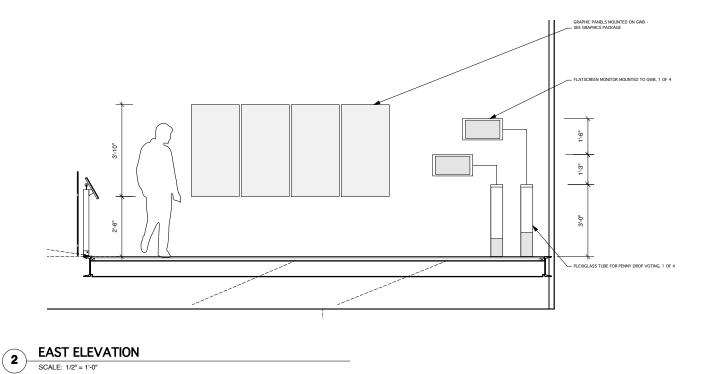

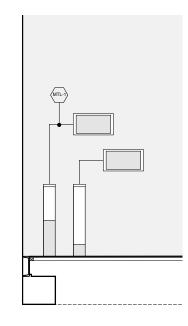



UTAH MUSEUM OF NATURAL HISTORY

UNIVERSITY OF UTAH, SALT LAKE CITY, UTAH

Leslie E. Robertson Associates 30 Broad Street New York, New York 10004 212.750.9000 tel.

Electrical/AV Engineer

BBI Engineering, Inc. 241 Quint Street San Francisco, CA 94124 415 685 9555 tel.

Exhibit Construction Key Plan

MORTH

	FD WS2rev	Sept.22, 2008
	FD WS2	Sept.9, 2008
١l	100% DD	June 2, 2008
/	XG 60% CD	May 5, 2008
	WS9	March. 26, 2008
	WS8	Feb. 20, 2008
	WS7	Dec. 18, 2007
	50% DD	Sept. 18, 2007
	WS6	July 11, 2007
	WS5	May 23, 2007
_	WS4	April 12, 2007

No. / Issue Name / Date


Sheet Title
Level 2 Details: Past Worlds
Clevland Lyod Quarry Project No.


No. / Issue Name / Date


0275

*Note: Scale Given for Full Size Drawing Sheet (22" x 34")

X2-PW-4.30

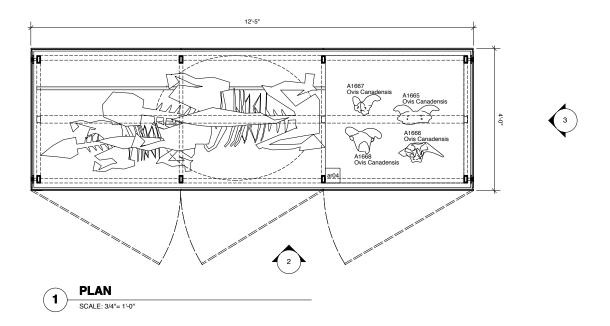

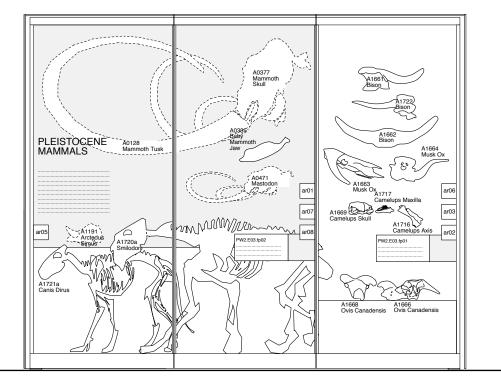

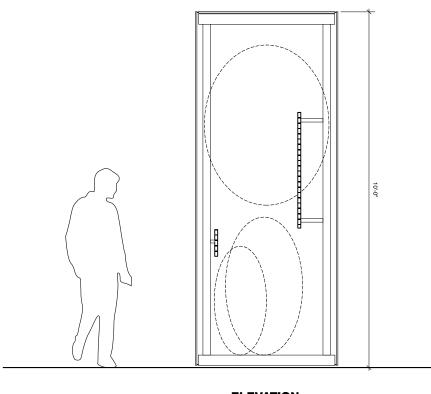

ELEVATION SCALE: 3/4"= 1'-0"

ELEVATION SCALE: 3/4"= 1'-0"

1. SEE X-TYP-1.00 FOR GLASS CASE SCHEDULE AND TYP. CASE DWGS FOR BRACKET & PANEL DTLS 2. SEE CASEWORK SPECIFICATIONS

UTAH MUSEUM OF NATURAL HISTORY

UNIVERSITY OF UTAH, SALT LAKE CITY, UTAH

0wner
UMNH 1390 East President's Circle Salt Lake City. Utah 84112
801 581 6927 tel





	FD WS2rev	Sept.22, 2008
	FD WS2	Sept.9, 2008
\wedge \cap	100% DD	June 2, 2008
	XG 60% CD	
NORTH		March. 26, 2008
7	WS8	Feb. 20, 2008
T I	WS7	Dec. 18, 2007
-	50% DD	Sept. 18, 2007
	WS6	July 11, 2007
	WS5	May 23, 2007
	WS4	April 12, 2007


June 2, 2008		
CD May 5, 2008		
March. 26, 2008		
Feb. 20, 2008		
Dec. 18, 2007		
Sept. 18, 2007		
July 11, 2007	80% FD	Dec.19, 2
May 23, 2007	FD WS4	Nov.18, 2
April 12, 2007	FD WS3	Oct.16, 2
Name / Date	No. / Issue N	Name / Date


	Sheet Title Exhibit Case L PW2.E03.ca0	_ayouts 1
	Date	Project No.
	Dec. 19, 2008	0275
80% FD Dec.19, 2008 FD WS4 Nov.18, 2008	- Scale*	Sheet No.
FD WS3 Oct.16, 2008	3/4"=1'-0"	Y2-D\M_5 1
N /I N /B ·		72-F VV-3. I

*Note: Scale Given for Full Size Drawing Sheet (22" x 34")

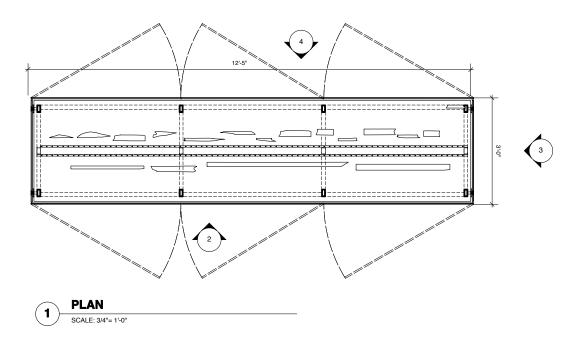

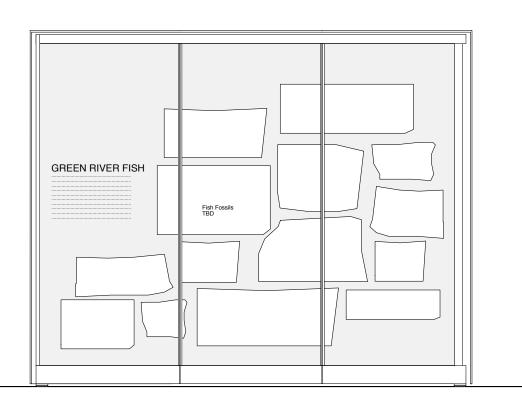

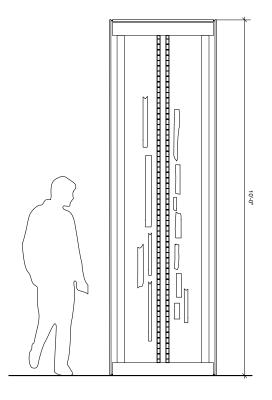

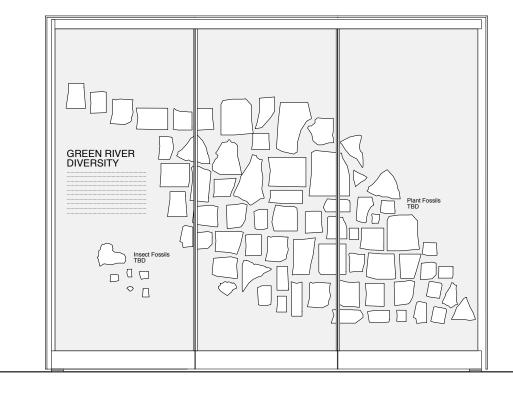







1. SEE X-TYP-1.00 FOR GLASS CASE SCHEDULE AND TYP. CASE DWGS FOR BRACKET & PANEL DTLS

UTAH MUSEUM OF NATURAL HISTORY

UNIVERSITY OF UTAH, SALT LAKE CITY, UTAH


Leslie E. Robertson Associates 30 Broad Street New York, New York 10004 212.750.9000 tel.

Mechanical/Plumbing/FP Engineer Colvin Engineering Associates, Inc. 244 West 300 North Salt Lake City, Utah 84103 801.322.2400 tel

Lighting Branston Partnership 122 West 26th Street New York, NY 10001 212.924.4050 tel.

BBI Engineering, Inc. 241 Quint Street San Francisco, CA 94124 415 685 9555 tel.

Exhibit Construction

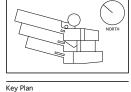

-	FD WS2	Sept.9, 2008
П	100% DD	June 2, 2008
Ή	XG 60% CD	
1	WS9	March. 26, 2008
1	WS8	Feb. 20, 2008
1	WS7	Dec. 18, 2007
1	50% DD	Sept. 18, 2007
1	WS6	July 11, 2007
1	WS5	May 23, 2007
Ξ	WS4	April 12, 2007
	No. / Issue Nan	ne / Date

FD WS2rev Sept.22, 2008

5ept.9, 2008	
ne 2, 2008	
May 5, 2008	
rch. 26, 2008	_
b. 20, 2008	_
ec. 18, 2007	
ept. 18, 2007	
uly 11, 2007	- 8
lay 23, 2007	Ŧ
pril 12, 2007	Ŧ


No. / Issue Name / Date


Sheet Title
Exhibit Case Layouts
PW3.E03.ca02 Date


3/4"=1'-0"


Project No. 0275 Dec. 19, 2008 Sheet No.

X2-PW-5.20

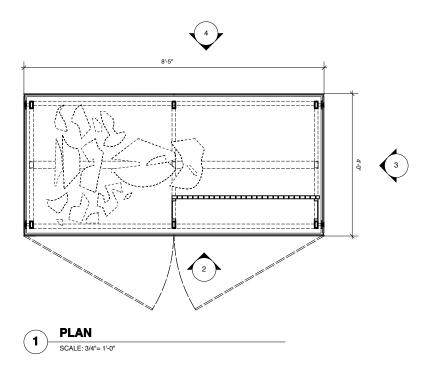

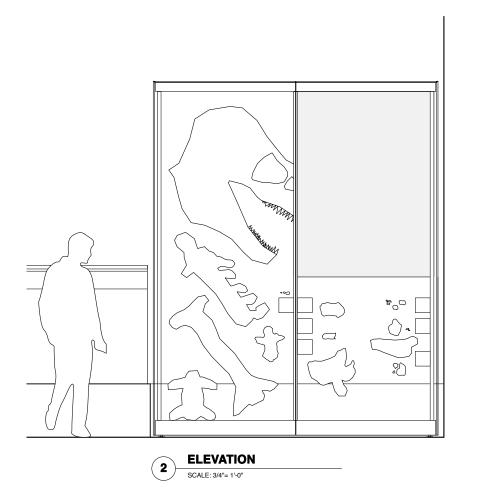

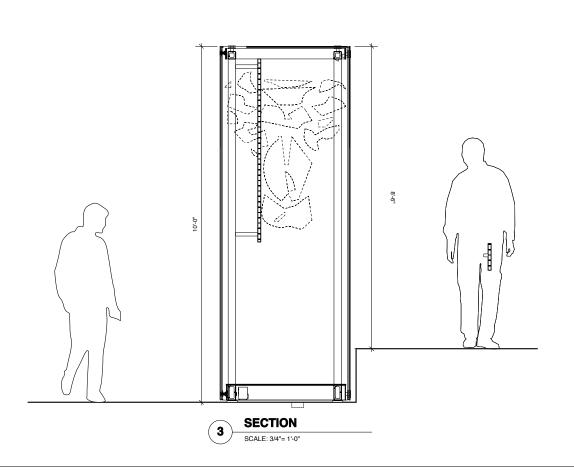

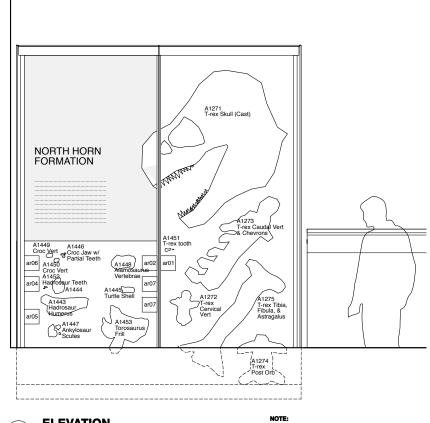



2. SEE CASEWORK SPECIFICATIONS

1. SEE X-TYP-1.00 FOR GLASS CASE SCHEDULE AND TYP. CASE DWGS FOR BRACKET & PANEL DTLS


UTAH MUSEUM OF NATURAL HISTORY

UNIVERSITY OF UTAH, SALT LAKE CITY, UTAH

Mechanical/Plumbing/FP Engineer

BBI Engineering, Inc. 241 Quint Street San Francisco, CA 94124 415 685 9555 tel.

Exhibit Construction

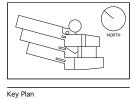

FD WS2rev	Sept.22, 2008
FD WS2	Sept.9, 2008
100% DD	June 2, 2008
XG 60% CL	
WS9	March. 26, 2008
WS8	Feb. 20, 2008
WS7	Dec. 18, 2007
50% DD	Sept. 18, 2007
WS6	July 11, 2007
WS5	May 23, 2007
WS4	April 12, 2007
No. / Issue Nar	ne / Date

800	
8	
800	
2008	
08	
007	
2007	
007	80% FD
007	FD WS4


No. / Issue Name / Date

Sheet Title
Exhibit Case Layouts
PW4.E09.ca03


Date Project No. 0275 Dec. 19, 2008


3/4"=1'-0" X2-PW-5.30


Sheet No.

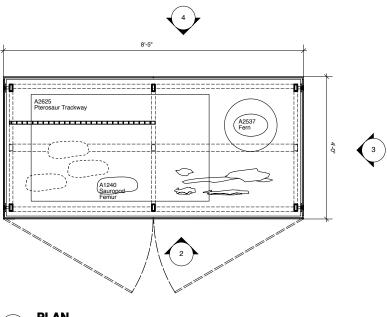



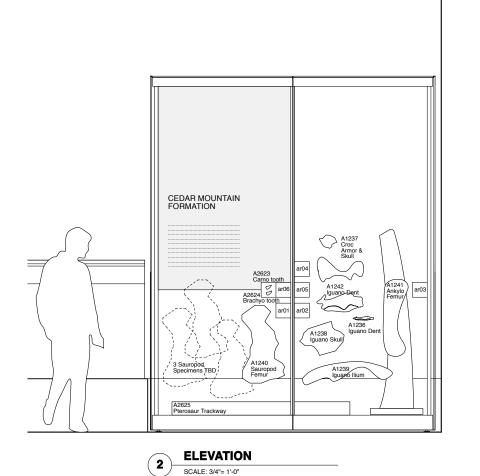

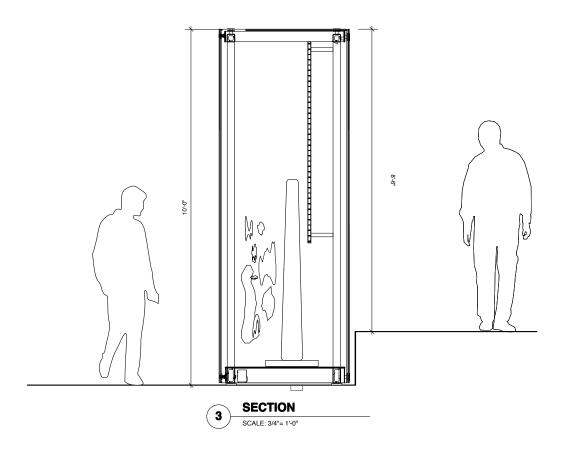

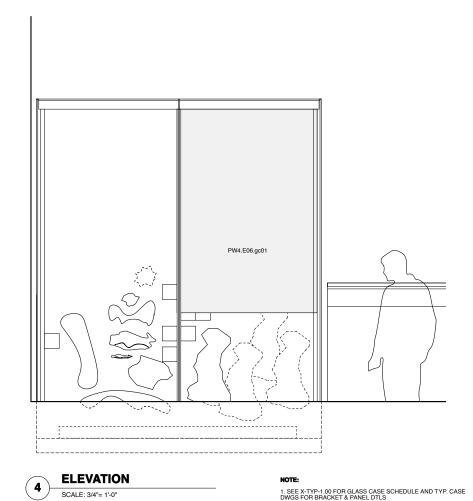

UTAH MUSEUM OF NATURAL HISTORY

UNIVERSITY OF UTAH, SALT LAKE CITY, UTAH

Owner	
UMNH 1390 East President's Circle Salt Lake City, Utah 84112 801 581 6927 tel	

Mechanical/Plumbing/FP Engineer

Exhibit Construction

	NORTH
Key Plan	


	FD WS2rev	Sept.22, 2008
\Box	FD WS2	Sept.9, 2008
71	100% DD	June 2, 2008
71	XG 60% CD	
	WS9	March. 26, 2008
	WS8	Feb. 20, 2008
	WS7	Dec. 18, 2007
	50% DD	Sept. 18, 2007
	WS6	July 11, 2007 May 23, 2007
	WS5	
	WS4	April 12, 2007

Sheet Title Level 2 Details: Past Worlds Exhibit Case PW4.E06.ca04 Project No.

2. SEE CASEWORK SPECIFICATIONS

Dec. 19, 2008

0275 Sheet No. 1/2"=1'-0" X2-PW-5.40

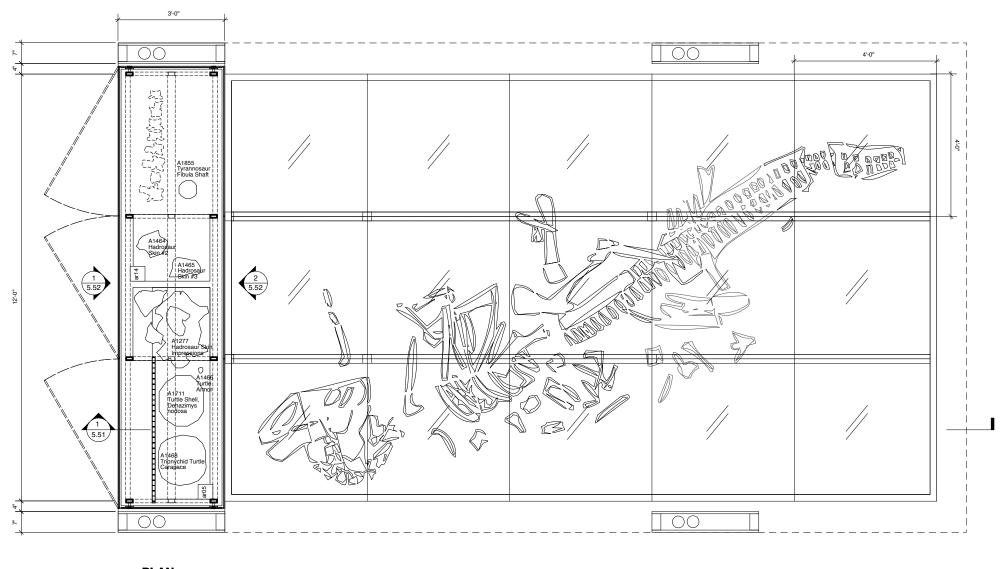

PLAN

SCALE: 3/4"= 1'-0"

UTAH MUSEUM OF NATURAL HISTORY

UNIVERSITY OF UTAH, SALT LAKE CITY, UTAH


Exhibit Construction

	FD WS2rev	Sept.22, 2008
7	FD WS2	Sept.9, 2008
		June 2, 2008
1	XG 60% CD	May 5, 2008
	WS9	March. 26, 2008
	WS8	Feb. 20, 2008
	WS7	Dec. 18, 2007
	50% DD	Sept. 18, 2007
	WS6	July 11, 2007
	WS5	May 23, 2007
	WS4	April 12, 2007
	No. / Issue Nam	ne / Date

	Sheet Title Exhibit Case L PW4.E03.ca05	
	Date	Project No.
	Dec. 19, 2008	0275
80% FD Dec.19, 2008 FD WS4 Nov.18, 2008	- Scale*	Sheet No.
FD WS3 Oct.16, 2008	3/4"=1'-0"	X2-PW-5.
No. / Issue Name / Date		72-1 VV-J.

*Note: Scale Given for Full Size Drawing Sheet (22" x 34")

1. SEE X-TYP-1.00 FOR GLASS CASE SCHEDULE AND TYP. CASE DWGS FOR BRACKET & PANEL DTLS

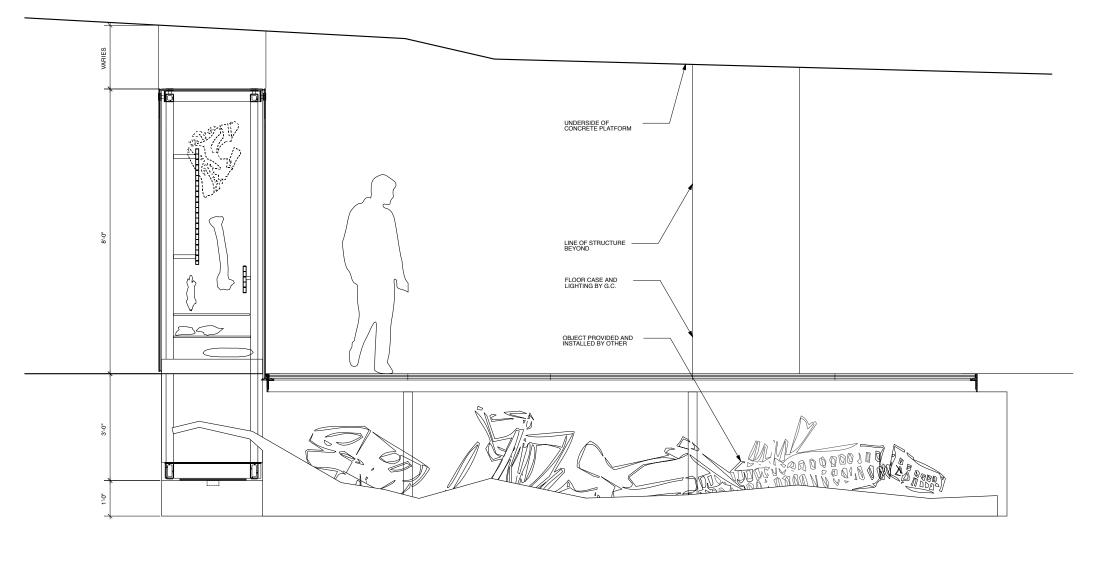

SECTION SCALE: 3/4"= 1'-0"

Exhibit Construction

UNIVERSITY OF UTAH, SALT LAKE CITY, UTAH

UTAH MUSEUM OF NATURAL HISTORY

Mechanical/Plumbing/FP Engineer

Lighting Branston Partnership 122 West 26th Street New York, NY 10001 212.924.4050 tel.

BBI Engineering, Inc. 241 Quint Street San Francisco, CA 94124 415 685 9555 tel.

Key Plan

	XG 60% (
ORTH	WS9	March. 26, 2008
	WS8	Feb. 20, 2008
	WS7	Dec. 18, 2007
	50% DD	Sept. 18, 2007
	WS6	July 11, 2007
	WS5	May 23, 2007
	WS4	April 12, 2007
	No. / Issue N	Name / Date


FD WS2rev Sept.22, 2008 FD WS2 Sept.9, 2008 100% DD June 2, 5008


Date Dec. 19, 2008

Sheet Title
Exhibit Case Layouts
PW4.E03.ca05 Project No. 0275 Sheet No. 3/4"=1'-0" X2-PW-5.51

1. SEE X-TYP-1.00 FOR GLASS CASE SCHEDULE AND TYP. CASE DWGS FOR BRACKET & PANEL DTLS

*Note: Scale Given for Full Size Drawing Sheet (22" x 34")

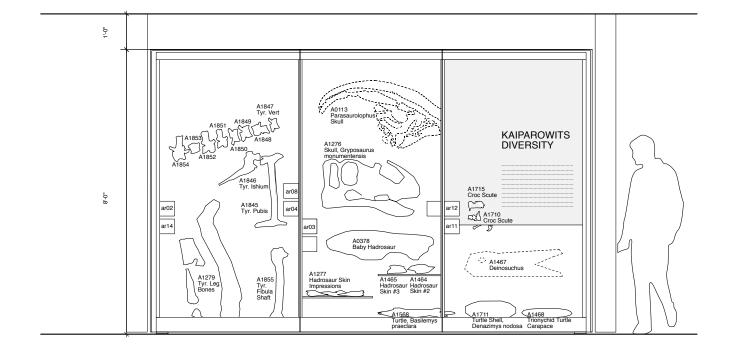

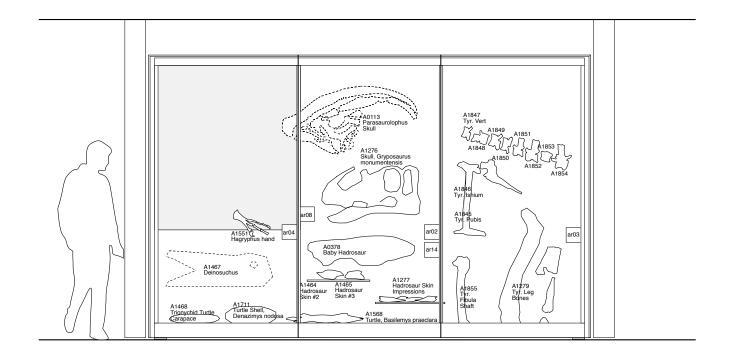

ELEVATION
SCALE: 3/4"= 1'-0"

ELEVATION SCALE: 3/4"= 1'-0"

1. SEE X-TYP-1.00 FOR GLASS CASE SCHEDULE AND TYP. CASE DWGS FOR BRACKET & PANEL DTLS


UTAH MUSEUM OF NATURAL HISTORY

UNIVERSITY OF UTAH, SALT LAKE CITY, UTAH

Mechanical/Plumbing/FP Engineer

BBI Engineering, Inc. 241 Quint Street San Francisco, CA 94124 415 685 9555 tel.

Exhibit Construction

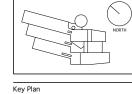



	I D WOZIEV	Ocpt.22, 200
	FD WS2	Sept.9, 2008
\ l	100% DD	June 2, 2008
1	XG 60% CD	
	WS9	March. 26, 2008
	WS8	Feb. 20, 2008
	WS7	Dec. 18, 2007
	50% DD	Sept. 18, 2007
1 .	WS6	July 11, 2007
	WS5	May 23, 2007
	WS4	April 12, 2007
	No. / Issue Nan	ne / Date

3 07 07 07 07 07

Sheet Title
Exhibit Case Layouts
PW4.E03.ca05 Date Project No. 0275 Dec. 19, 2008 Sheet No. 3/4"=1'-0"

X2-PW-5.52

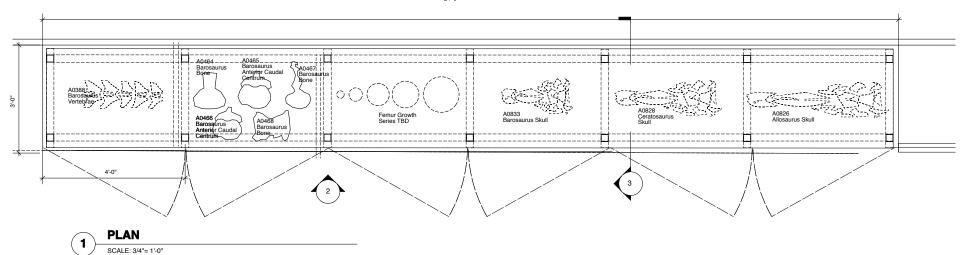

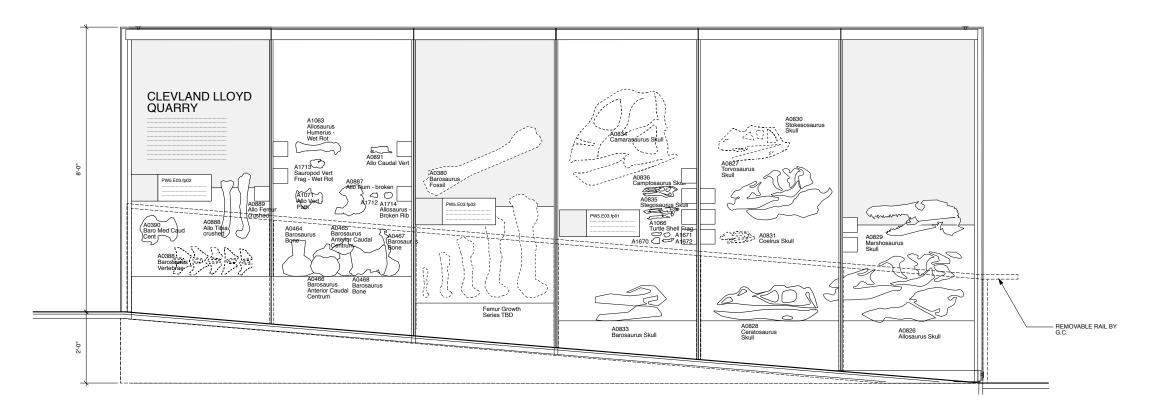



1. SEE X-TYP-1.00 FOR GLASS CASE SCHEDULE AND TYP. CASE DWGS FOR BRACKET & PANEL DTLS

2. SEE CASEWORK SPECIFICATIONS

3. PHOTOMURAL ON PW SOUTH WALL CONTINUES BEHIND CASE

UTAH MUSEUM OF NATURAL HISTORY

UNIVERSITY OF UTAH, SALT LAKE CITY, UTAH

Owner	De
UMNH 1390 East President's Circle Salt Lake City, Utah 84112	Po 32 Ne

Mechanical/Plumbing/FP Engineer




	FD WS2rev	/ Sept.22, 2008	
7	FD WS2	Sept.9, 2008	
) [100% DD	June 2, 2008	
71	XG 60% C		
	WS9	March. 26, 2008	
	WS8	Feb. 20, 2008	
	WS7	Dec. 18, 2007	
	50% DD	Sept. 18, 2007	
	WS6	July 11, 2007	80
	WS5	May 23, 2007	FI
_	WS4	April 12, 2007	F

No. / Issue Name / Date

, 2008	
800	
2008	
5, 2008	
2008	
, 2007	
3, 2007	
2007	80% FD
2007	FD WS4
, 2007	FD WS3

	Sheet Title Exhibit Case LAYOUTS PW5.E03.ca06	
	Date	Project No.
	Dec. 19, 2008	0275
80% FD Dec.19, 2008 FD WS4 Nov.18, 2008	- Scale*	Sheet No.
FD WS3 Oct.16, 2008	3/4"=1'-0"	X2-PW-5.60
No. / Issue Name / Date		72-1 VV-J.00

*Note: Scale Given for Full Size Drawing Sheet (22" x 34")

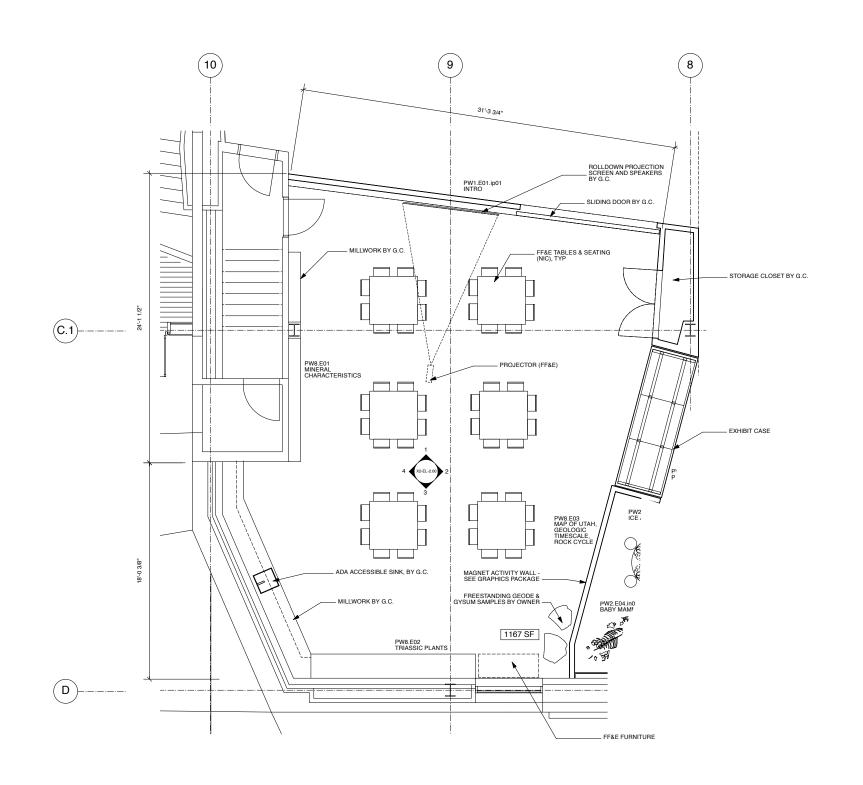

UTAH MUSEUM OF NATURAL HISTORY

UNIVERSITY OF UTAH, SALT LAKE CITY, UTAH

Leslie E. Robertson Associates 30 Broad Street New York, New York 10004 212.750.9000 tel.

Electrical/AV Engineer

BBI Engineering, Inc. 241 Quint Street San Francisco, CA 94124 415 685 9555 tel.

Ralph Appelbaum Associates 88 Pine Street New York, New York 10005 212.334.8200 tel.



	FD WS2rev	Sept.22, 200
$\overline{}$	FD WS2	Sept.9, 2008
-)	100% DD	June 2, 2008
	XG 60% CD	
TH	WS9	March. 26, 200
	WS8	Feb. 20, 2008
	WS7	Dec. 18, 200
	50% DD	Sept. 18, 200
	WS6	July 11, 2007
	WS5	May 23, 2007
	WS4	April 12, 2007


No. / Issue Name / Date

80% FD Dec.19, 2008 FD WS4 Nov.18, 2008 FD WS3 Oct.16, 2008 No. / Issue Name / Date


Sheet Title Level 2 Partial Plan: Earth Lab

Project No. 0275 Sheet No.


X2-EL-1.00

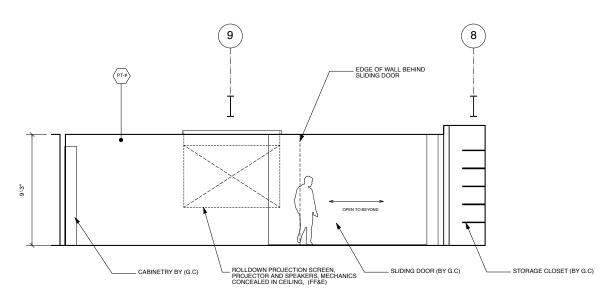




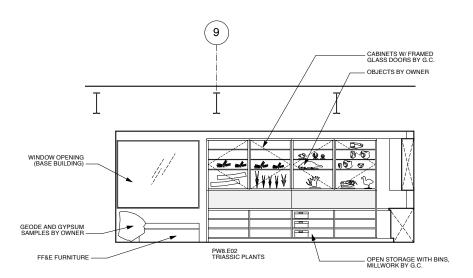



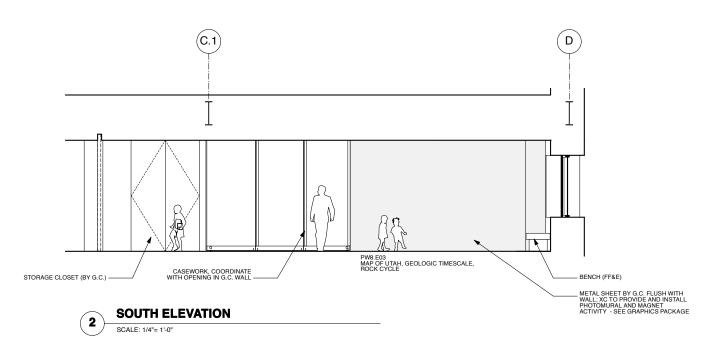

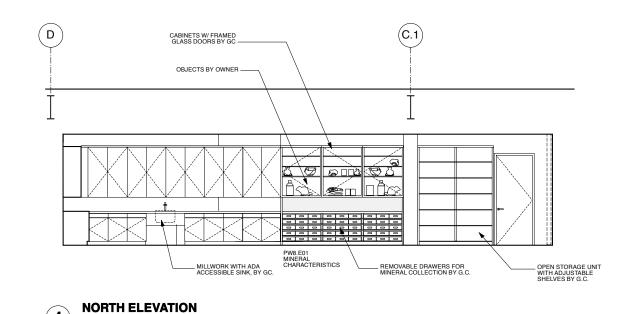



UNIVERSITY OF UTAH, SALT LAKE CITY, UTAH

Structural Engineer Leslie E. Robertson Associates 30 Broad Street New York, New York 10004 212.750.9000 tel.

Mechanical/Plumbing/FP Engineer Colvin Engineering Associates, Inc. 244 West 300 North Salt Lake City, Utah 84103 801.322.2400 tel Electrical/AV Engineer Spectrum Engineers 175 South Main Street Salt Lake City, Utah 84111 800.678.7077 tel Landscape Architect

Lighting

BBI Engineering, Inc. 241 Quint Street San Francisco, CA 94124 415 685 9555 tel.

Exhibit Construction

SCALE: 1/4"= 1'-0"

Ralph Appelbaum Associates 88 Pine Street New York, New York 10005 212.334.8200 tel.

Key Plan

FD WS2rev Sept.22, 2008 FD WS2 Sept.22, 2008

FD WS2 Sept.9, 2008

100% DD June 2, 2008

XG 60% CD May 5, 2008

WS9 March. 26, 2008 July 11, 2007 May 23, 2007 April 12, 2007

No. / Issue Name / Date

80% FD Dec.19, 2008 FD WS4 Nov.18, 2008 FD WS3 Oct.16, 2008 No. / Issue Name / Date

Level 2 Partial Plan: Earth Lab Date

Project No. 0275 Sheet No. Scale*

X2-EL-2.00